


HAVE ALL SERVICE PROVIDERS LOCATE THEIR UNDERGROUND SERVICES BEFORE PERFORMING ANY NEW SITE UTILITY WORK.

- NOTES INDICATED BY "C"
- NEW CHILLER YARD TO HOUSE TWO 100-TON NOMINAL AIR-COOLED PACKAGED CHILLERS, CH-1 AND CH-2. PROVIDE NEW 8' ARCHITECTURAL VISION PANEL - REFER TO SPECIFICATIONS. PROVIDE LOCKING GATE FOR MAINTENANCE ACCESS CONSTRUCTED OF VISION PANEL.
 - DIRECT BURIED 6" CHILLED WATER SUPPLY AND RETURN, PREINSULATED PIPING AND 2" NON-METALLIC LIQUIDTIGHT FLEXIBLE CONDUIT WITH PULL ROPE. PROVIDE BORE PIT ON BOTH ENDS. CAREFULLY LOCATE ANY UNDERGROUND UTILITIES PRIOR TO BORE, BY HAND EXCAVATION.
 - BORE PIT FOR DIRECT BURIED PIPING
 - NEW LOCATION FOR 150 KW (NATURAL GAS) 277/480V/3PH GENERATOR SET ON NEW 6" CONCRETE SLAB. RELOCATE THE EXISTING ROOF MOUNTED GENERATOR TO NEW LOCATION. PROVIDE NEW FEEDER TO EXISTING AUTOMATIC TRANSFER SWITCH AND NEW FEEDER FOR NEW PANEL "NG" FROM NEW PANEL "YC". PROVIDE A MINIMUM CLEARANCE OF 5' AROUND GENERATOR ENCLOSURE.
 - THE EXISTING AUTOMATIC TRANSFER SWITCH IS A THREE POLE TRANSFER SWITCH, SO THE EMERGENCY GENERATOR IS NOT A SEPARATELY DERIVED SOURCE. NEUTRAL AND GROUND ARE NOT BONDED AT THIS LOCATION, BUT DO PROVIDE A SUPPLEMENTAL GROUND ROD AT EMERGENCY GENERATOR.
 - NEW UNDERGROUND ELECTRICAL FEED FROM NEW GENERATOR TO EXISTING AUTOMATIC TRANSFER SWITCH. REFER TO ELECTRICAL. PROVIDE BORE PIT ON BOTH ENDS. CAREFULLY LOCATE ANY UNDERGROUND UTILITIES PRIOR TO BORE, BY HAND EXCAVATION.
 - CONNECT NEW GAS LINE TO EXISTING IN THE STREET AND ROUTE TO NEW METER/REGULATOR AS INDICATED. COORDINATE WITH THE GAS COMPANY. MAKE FINAL CONNECTIONS TO RELOCATED GENERATOR (2,061 MBH).
 - BOTH ANNEX AND ENTIRE COURTHOUSE BUILDING TO BE REROOFED TO MEET HISTORICAL COMMISSION REQUIREMENTS (NOT IN SCOPE OF THIS PROJECT-REFER TO ROOF REPLACEMENT PROJECT).
 - NEW UTILITY POLE AND NEW ELECTRICAL SERVICE WITH CT ON POLE AND METER BASE ON POLE. COORDINATE AND PROVIDE ALL REQUIREMENTS AS DIRECTED BY UTILITY COMPANY FOR NEW SERVICE. FIELD VERIFY WORK REQUIRED.
 - NEW MAIN SERVICE DISCONNECTS CONSIST OF TWO(2) 400A/3P DISCONNECTS WITH 300 RK-5 FUSES AND ONE 15 KVA TRANSFORMER/PANEL "YC" (ASSEMBLY HAS MAIN BREAKER) MOUNTED ON PAINTED STEEL TUBE FRAME.
 - NEW UNDERGROUND SERVICE TO POLE. SAW CUT PAVING AND REPLACE TO MATCH EXISTING.
 - ADD TO INSIDE OF RELOCATED GENERATOR ENCLOSURE A NEW PANEL "NG" AND TWO LIGHT FIXTURES EQUAL TO WITH TWO LIGHT SWITCHES AT EAST AND WEST DOORS INSIDE OF ENCLOSURE.
 - POSSIBLE LOCATION FOR COPPER PHONE LINES. FIELD VERIFY.
 - POSSIBLE LOCATION FOR FIBER OPTIC CABLE. FIELD VERIFY.
 - REFER TO M105 FOR PIPE STAND DETAIL.
 - AUTOMATIC BUTTERFLY VALVES, 4" SIZE.
 - HEAT TRACE, INSULATE, AND METAL JACKET ALL EXPOSED PIPING. CONNECT HEAT TRACE TO PANEL "YC".
 - REFER TO ROOF REPLACEMENT PROJECT FOR ROOF DRAIN WORK.
 - EXISTING SCUPPER/GUTTER DRAIN SERVING ANNEX TO REMAIN.
 - EXISTING 2" GAS LINE(2PSI) LINE TO ROOF - TO SERVE NEW DOAS UNITS (2).
 - EXISTING 2" GAS LINE(2PSI) TO EXISTING BOILERS(1000MBH EA).
 - EXISTING NATURAL GAS LINE TO REMAIN (VERIFY WITH ATMOS EXACT ROUTE).
 - EXTEND TWO 1" UNDERGROUND CONDUITS TO EACH CHILLER FROM PANEL "YC".

EXISTING	DEMOLISH	NEW	DESCRIPTION
CHS	CHS	CHS	CHILLED WATER SUPPLY
CHR	CHR	CHR	CHILLED WATER RETURN
S	S	S	STEAM (S=PRESSURE)
D	D	D	COND. DRAIN LINE
HWS	HWS	HWS	HEATING WATER SUPPLY
HWR	HWR	HWR	HEATING WATER RETURN
AR	AR	AR	ATMOSPHERIC RELIEF LINE
BT	BT	BT	BUCKET TRAP
FT	FT	FT	FLOAT AND THERMOSTATIC TRAP
GV	GV	GV	GATE VALVE
GLV	GLV	GLV	GLOBE VALVE
BLV	BLV	BLV	BALL VALVE
BV	BV	BV	BUTTERFLY VALVE
PV	PV	PV	PLUG VALVE
PRV	PRV	PRV	PRESSURE REDUCING VALVE
AV	AV	AV	AUTOMATIC VALVE
ATV	ATV	ATV	AUTOMATIC 3-WAY VALVE
CV	CV	CV	CHECK VALVE
TW	TW	TW	THERMOMETER WELL
TM	TM	TM	THERMOMETER
GC	GC	GC	GAGE COCK
GCG	GCG	GCG	GAGE COCK WITH GAGE
ST	ST	ST	STRAINER
SBV	SBV	SBV	STRAINER WITH BLOWOFF VALVE
UN	UN	UN	UNION
AVT	AVT	AVT	AUTOMATIC AIR VENT
FC	FC	FC	FLEXIBLE CONNECTION - PIPING
CR	CR	CR	CONCENTRIC REDUCER
ECR	ECR	ECR	ECCENTRIC REDUCER
FD	FD	FD	FLOW IN DIRECTION OF ARROW
PD	PD	PD	PITCH DOWN IN DIRECTION SHOWN
RU	RU	RU	RISE UP
RD	RD	RD	RISE DOWN
RO	RO	RO	RISE OR DROP
BCO	BCO	BCO	BRANCH CONNECTION OUT OF TOP
BCB	BCB	BCB	BRANCH CONNECTION OUT OF BOTTOM
BCS	BCS	BCS	BRANCH CONNECTION OUT OF SIDE
CE	CE	CE	CAP ON END OF PIPE
12X6	12X6	12X6	DUCTWORK - FIRST NUMBER IS VISIBLE DIMENSION
ME	ME	ME	MITERED ELBOW WITH TURNING VANES
DD	DD	DD	DROP IN DUCT
RI	RI	RI	RISE IN DUCT
SD	SD	SD	SUPPLY DIFFUSER
RD	RD	RD	RETURN DIFFUSER
FD	FD	FD	FIRE DAMPER
FSD	FSD	FSD	FIRE/SMOKE DAMPER
T	T	T	THERMOSTAT
CE	CE	CE	CONNECT TO EXISTING

SITE LEGEND	
SYMBOL	DESCRIPTION
S	SANITARY SEWER
F	FIRE LINE
W	WATER LINE
MH	MANHOLE - SEWER
SS	STORM SEWER
G	GAS LINE
GR	GAS REGULATOR

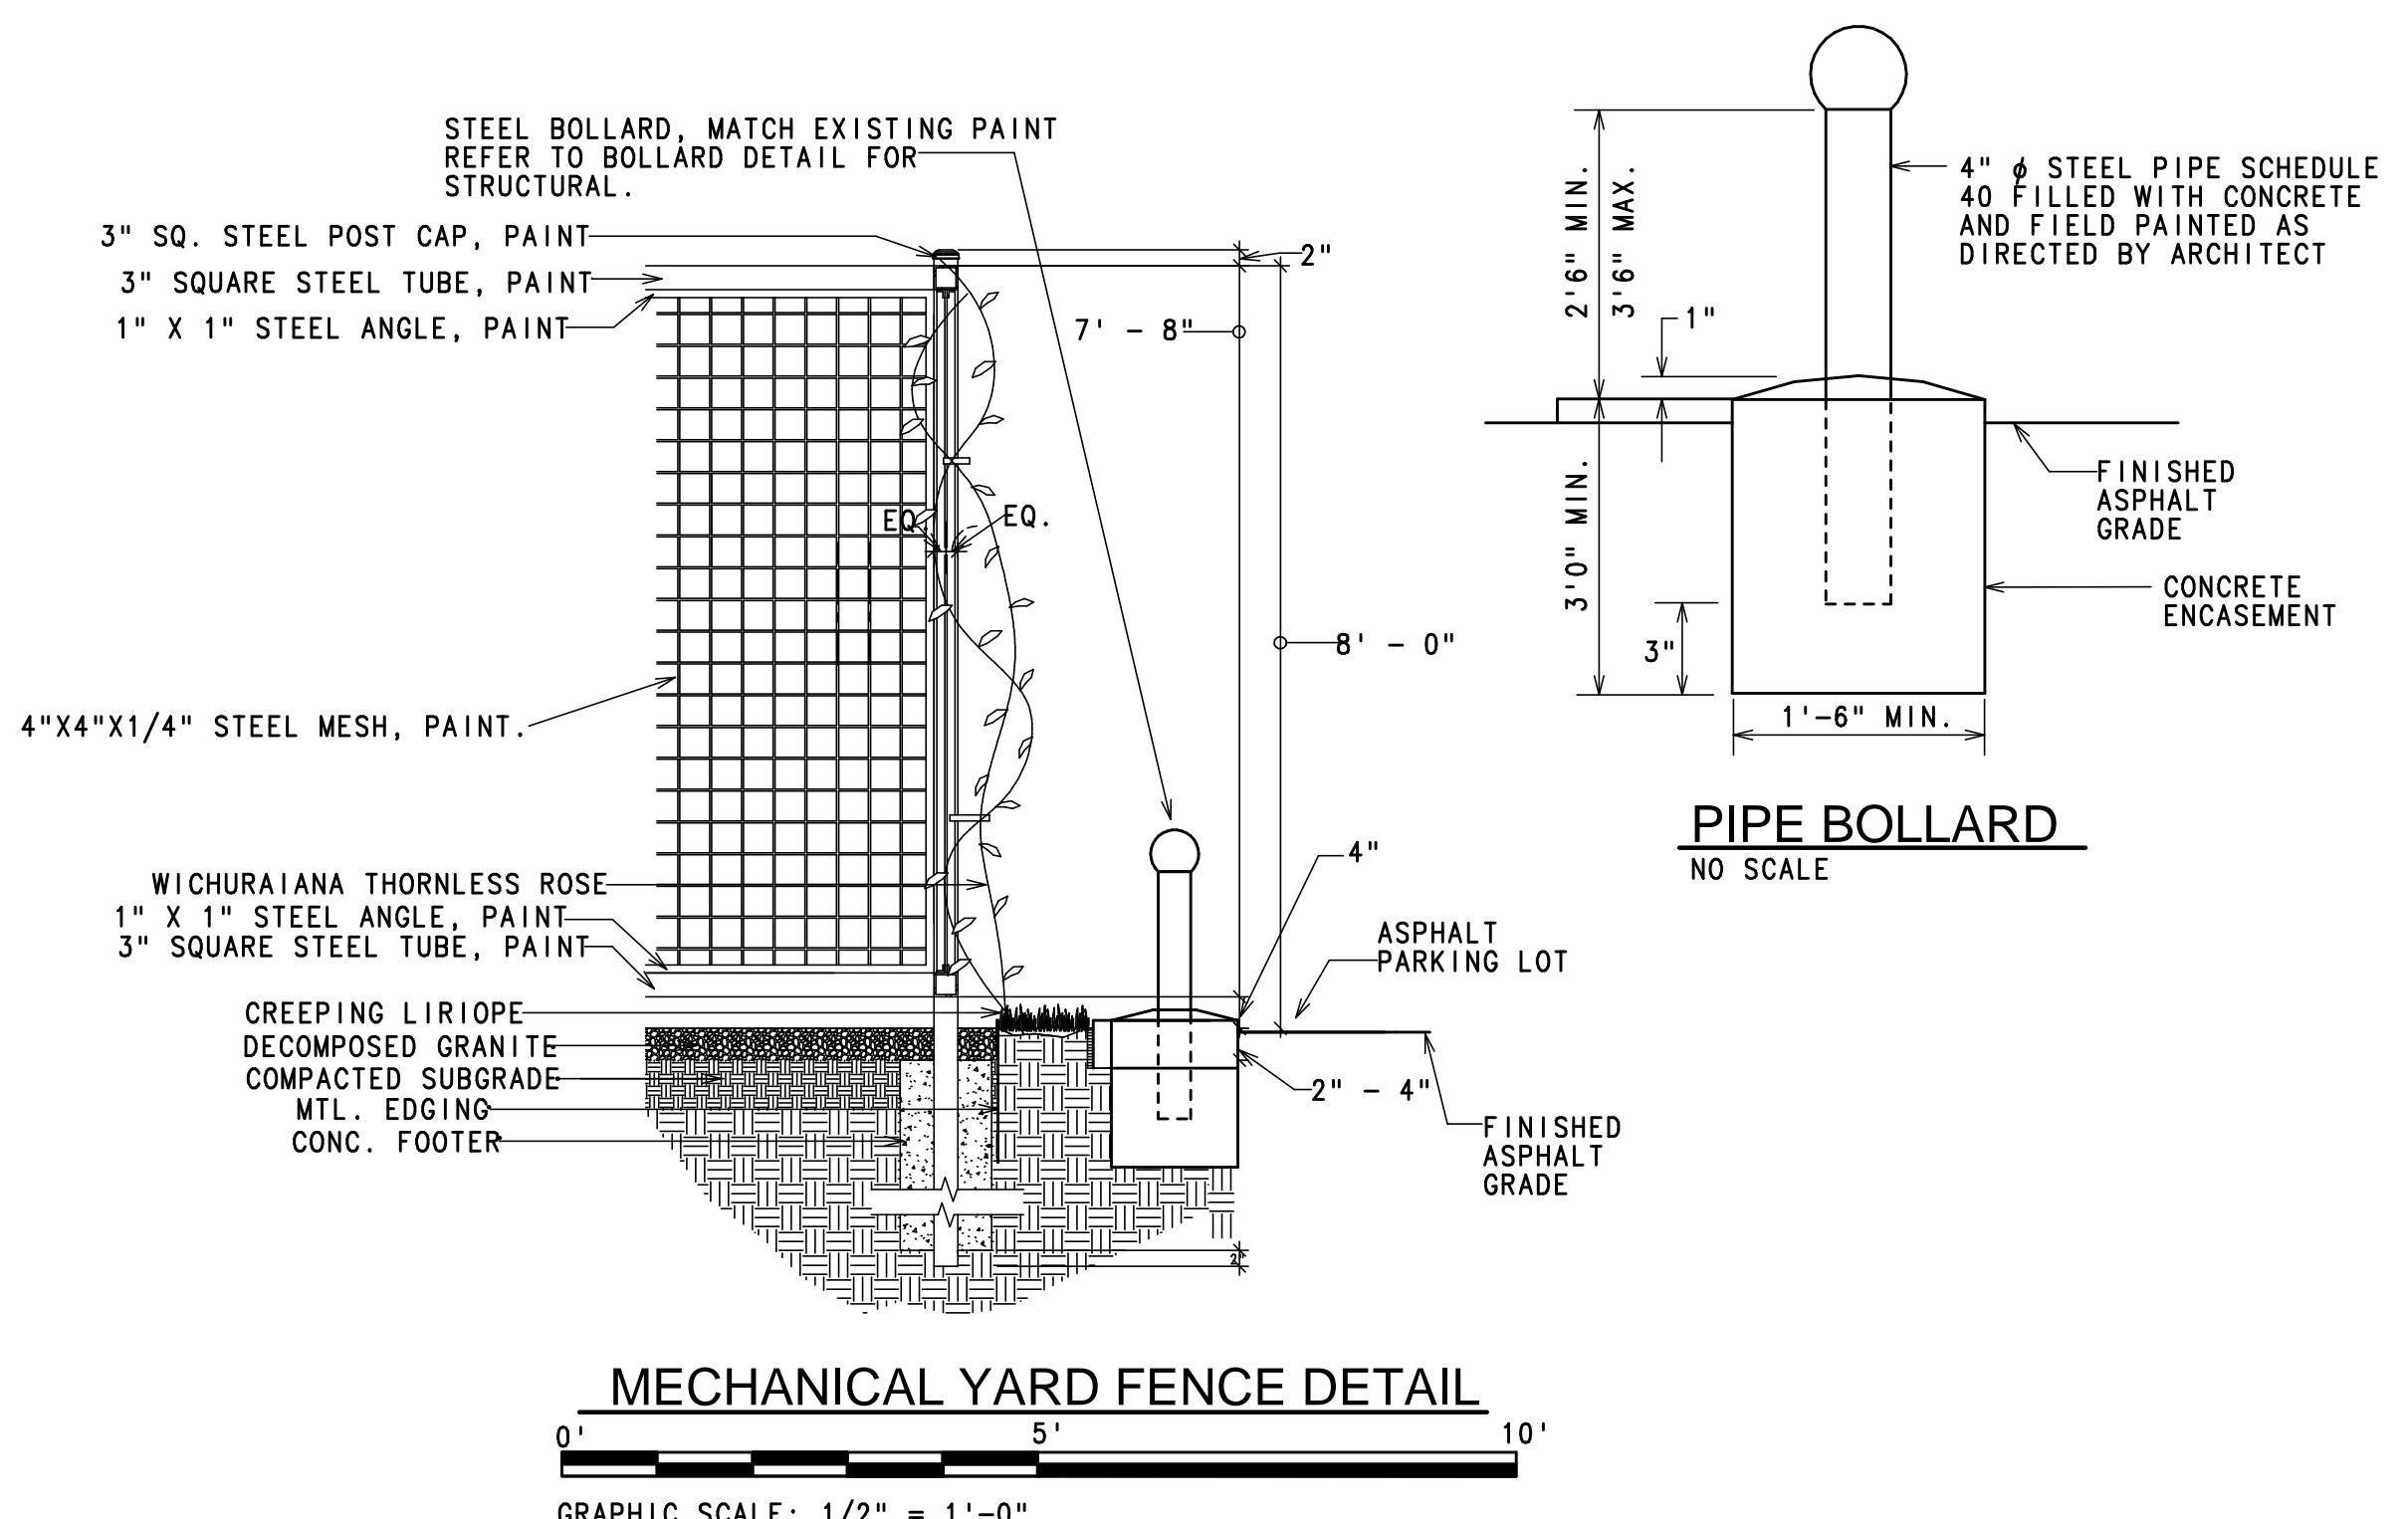

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HVAC SYSTEM RENOVATION PHASE 1
119 NORTH MAIN PARIS, TEXAS 75460

REVISIONS


NO.	DATE	DESCRIPTION
1	08/31/2022	ISSUE FOR BIDS

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DESIGN BY:

DRAWING NAME:
SITE PLAN

JOB: 21038B
DATE: 08/31/2022
SHEET NO.

MPE001

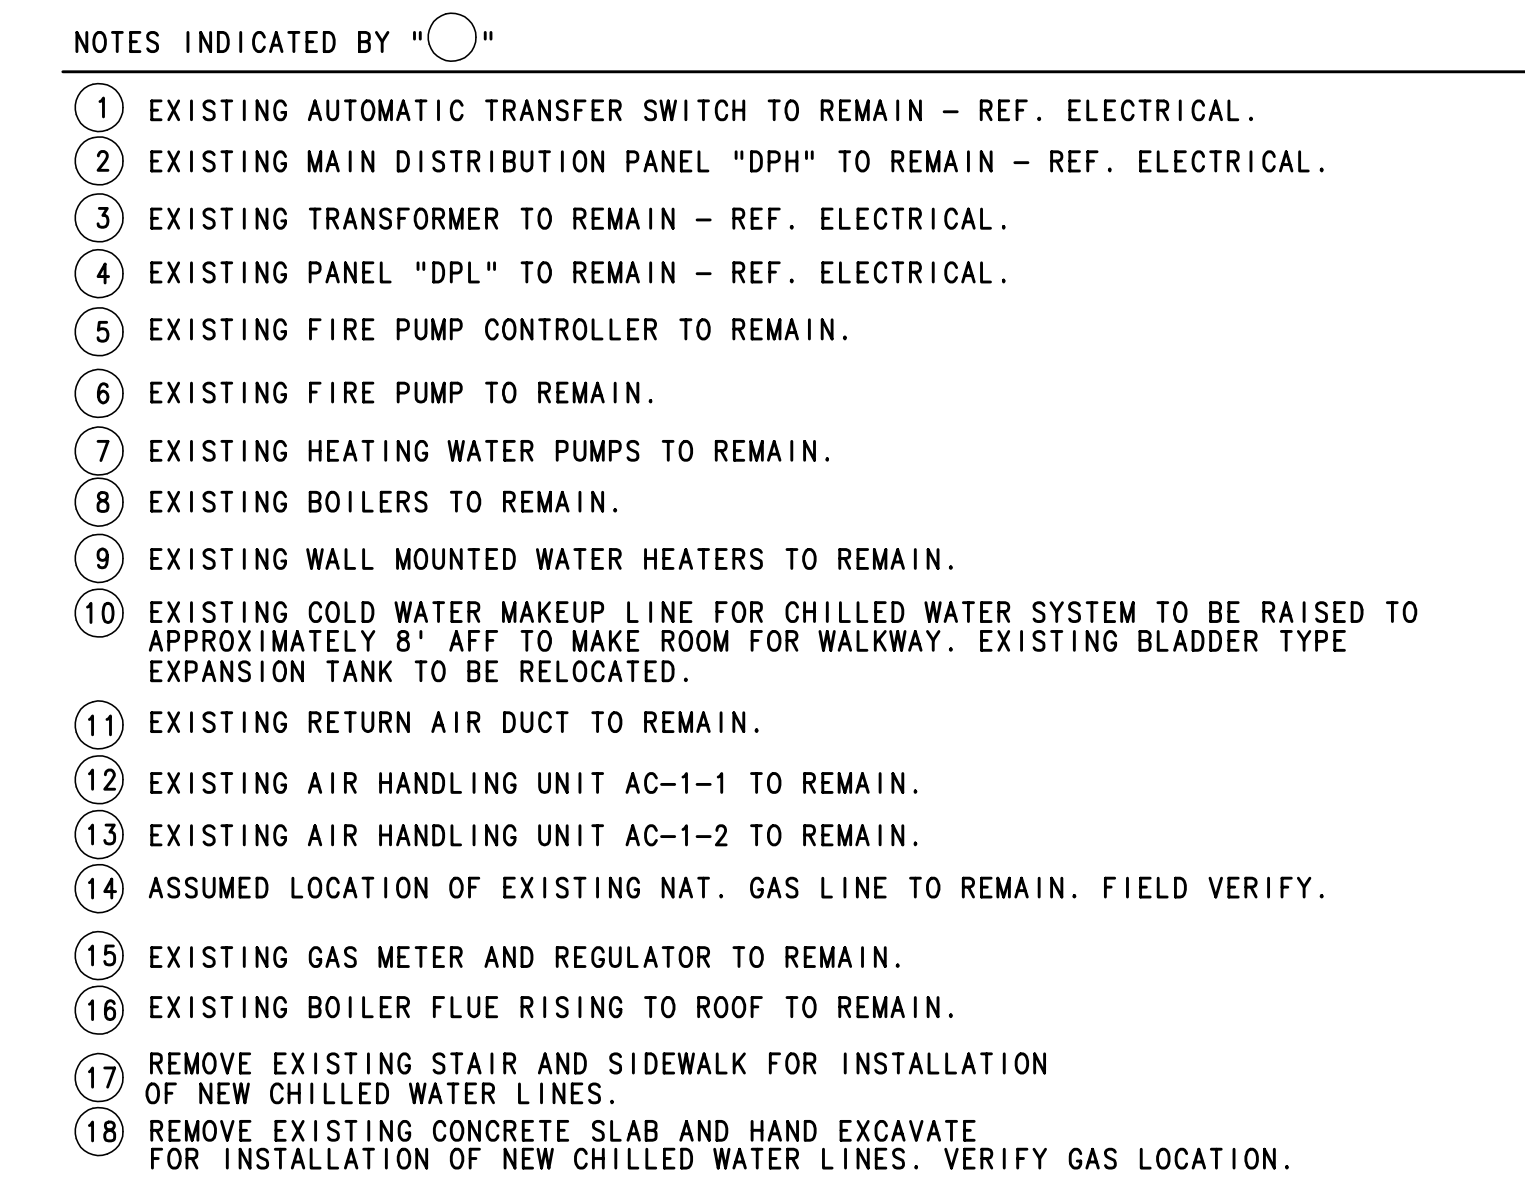

GRAPHIC SCALE: $\frac{3}{16}'' = 1' - 0''$



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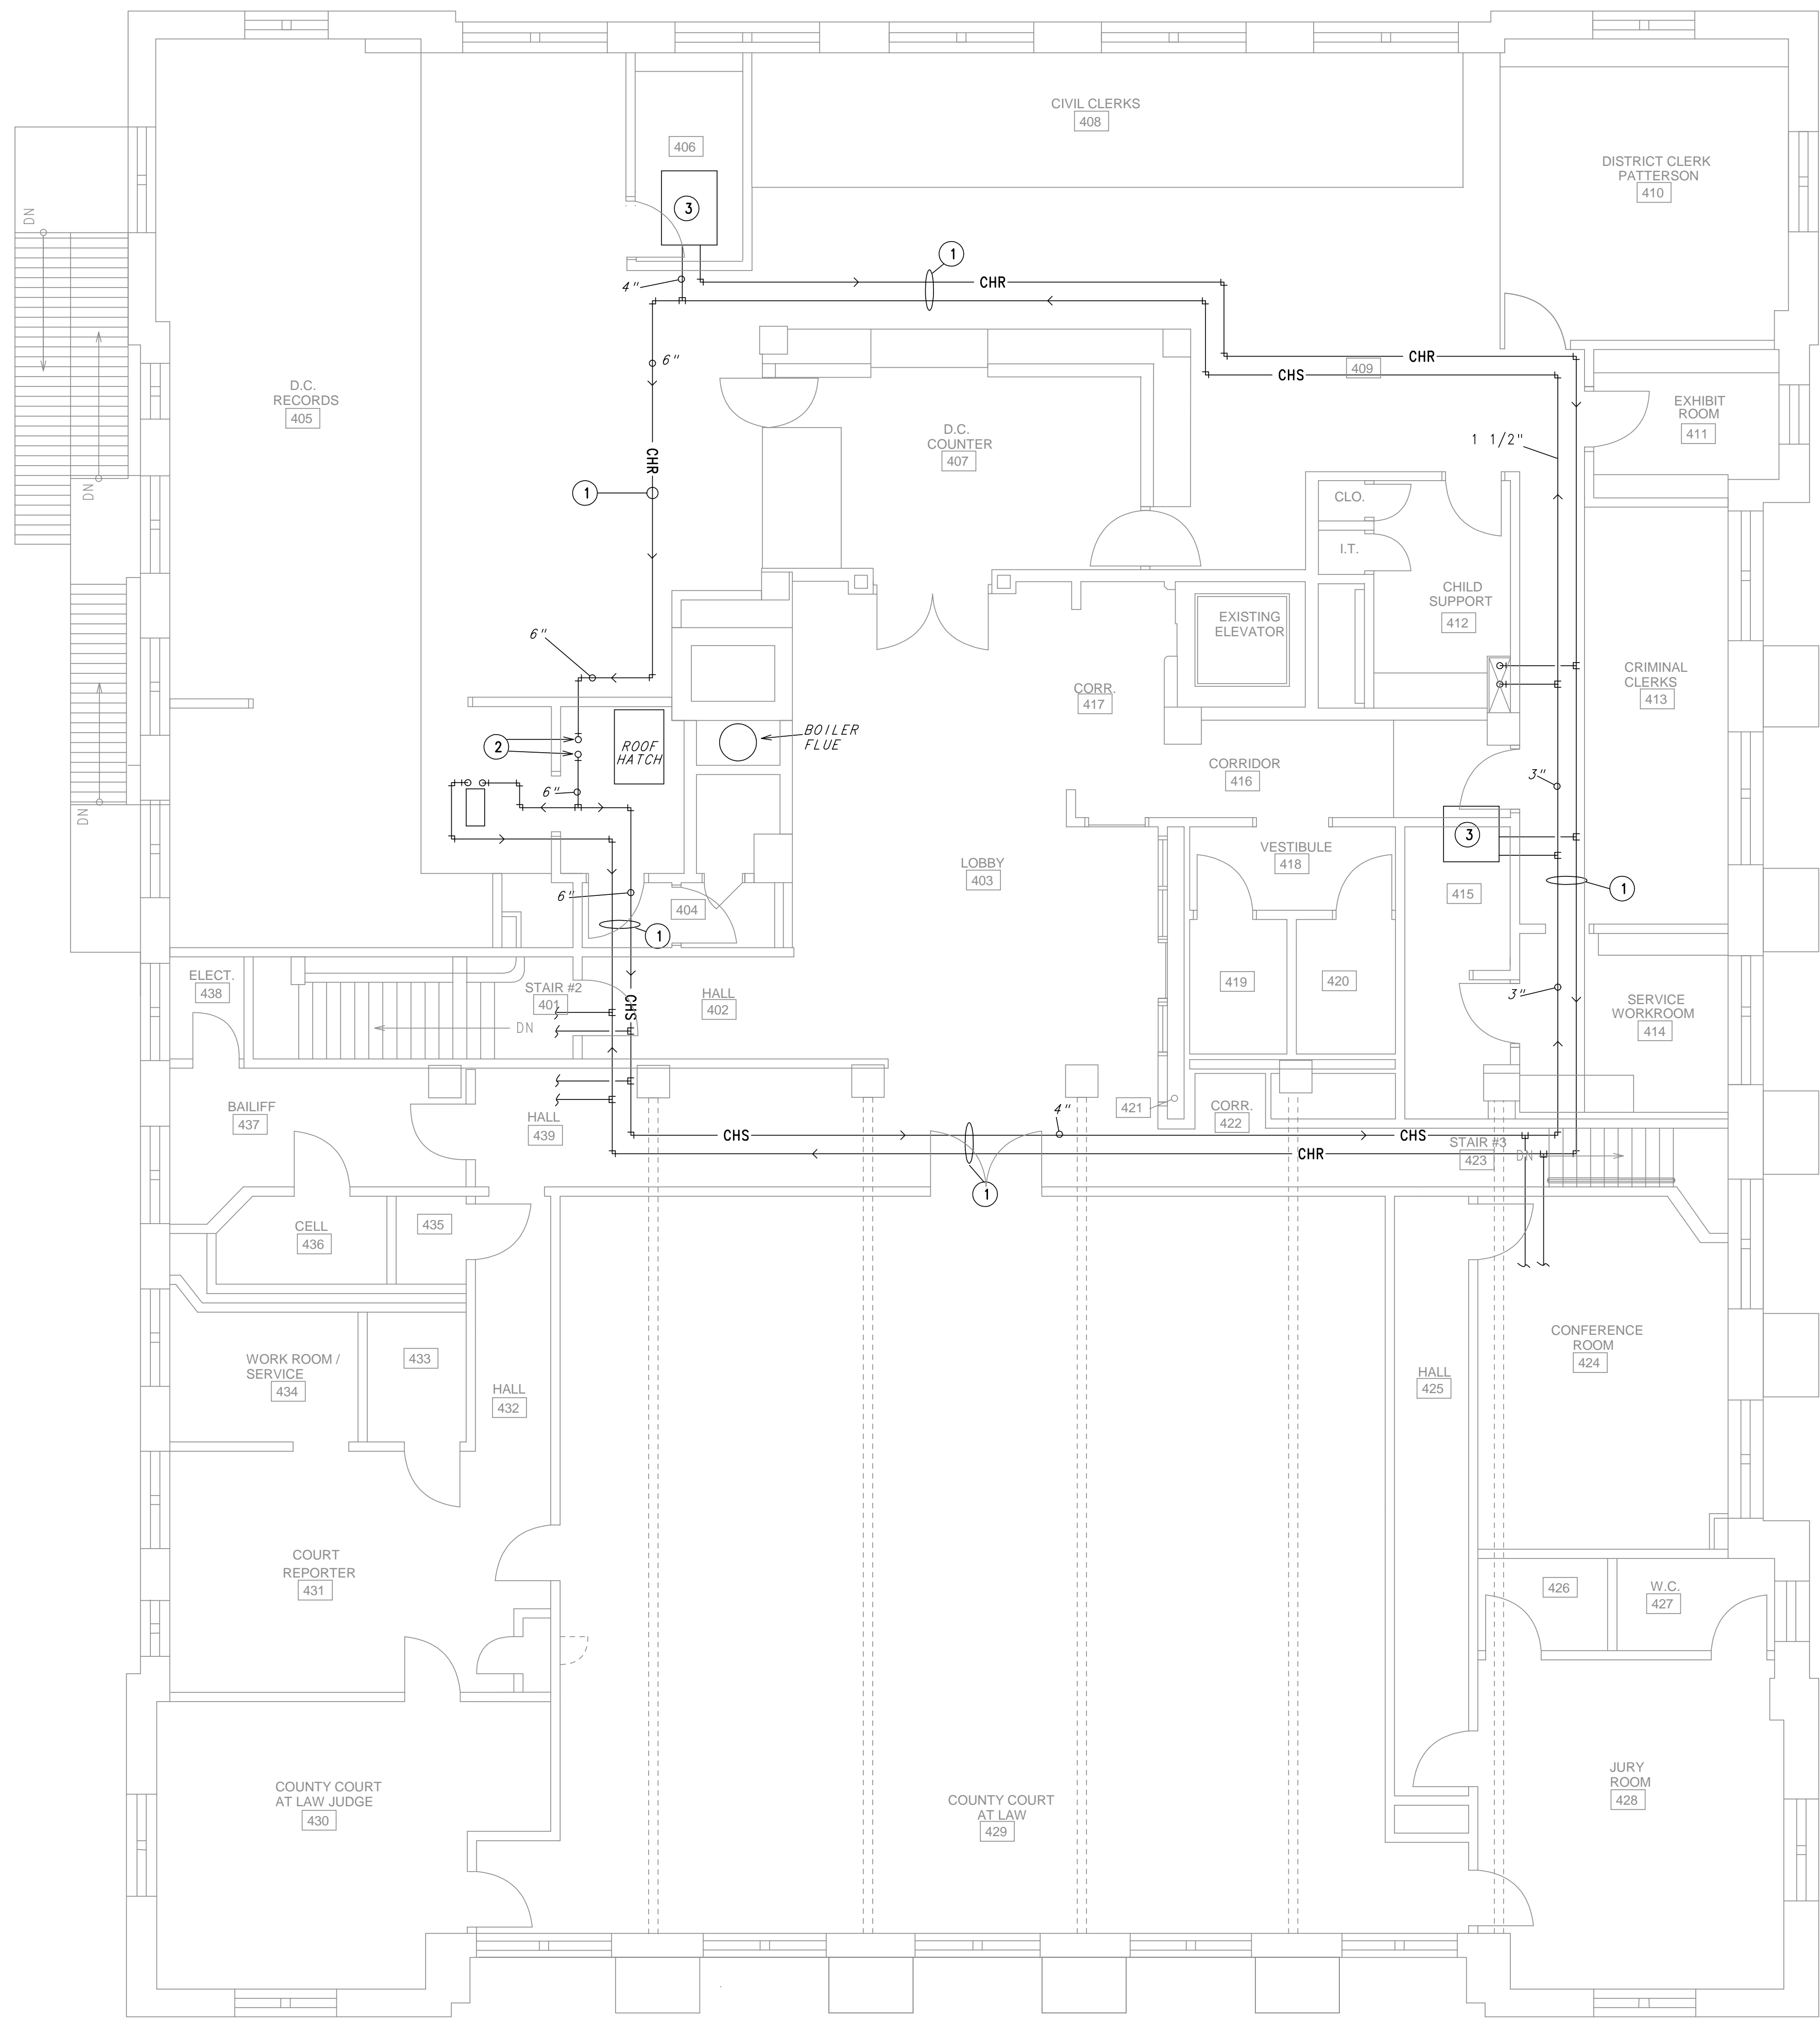
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DRAWING NAME:

**MECHANICAL
DEMOLITION
BASEMENT
FLOOR PLAN**

JOB:	21038B
DATE:	08/31/2022
SHEET No.	

M000




DEMOLITION 4TH FLOOR PLAN - MECHANICAL

GRAPHIC SCALE: 3/16" = 1'-0"



- NOTES INDICATED BY "○":
- EXISTING REVERSE RETURN LOOP IN 4TH FLOOR CEILING TO REMAIN
 - EXISTING 6" CHILLED WATER SUPPLY AND RETURN UP TO ROOF. CAP PIPING BELOW ROOF. INSTALL AUTOMATIC AIR VENTS AT TOP OF RISER AND CONNECT NEW PIPING AT THIS POINT. ROUTE DRAIN FROM AUTO AIR VENT TO NEAREST SINK OR SINK TRAP.
 - EXISTING BOILER COIL TO REMAIN.

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LICENSE #61441 ON 08/31/2022
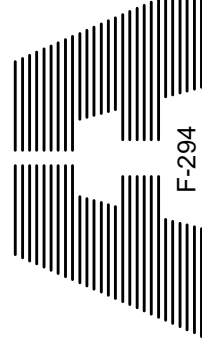
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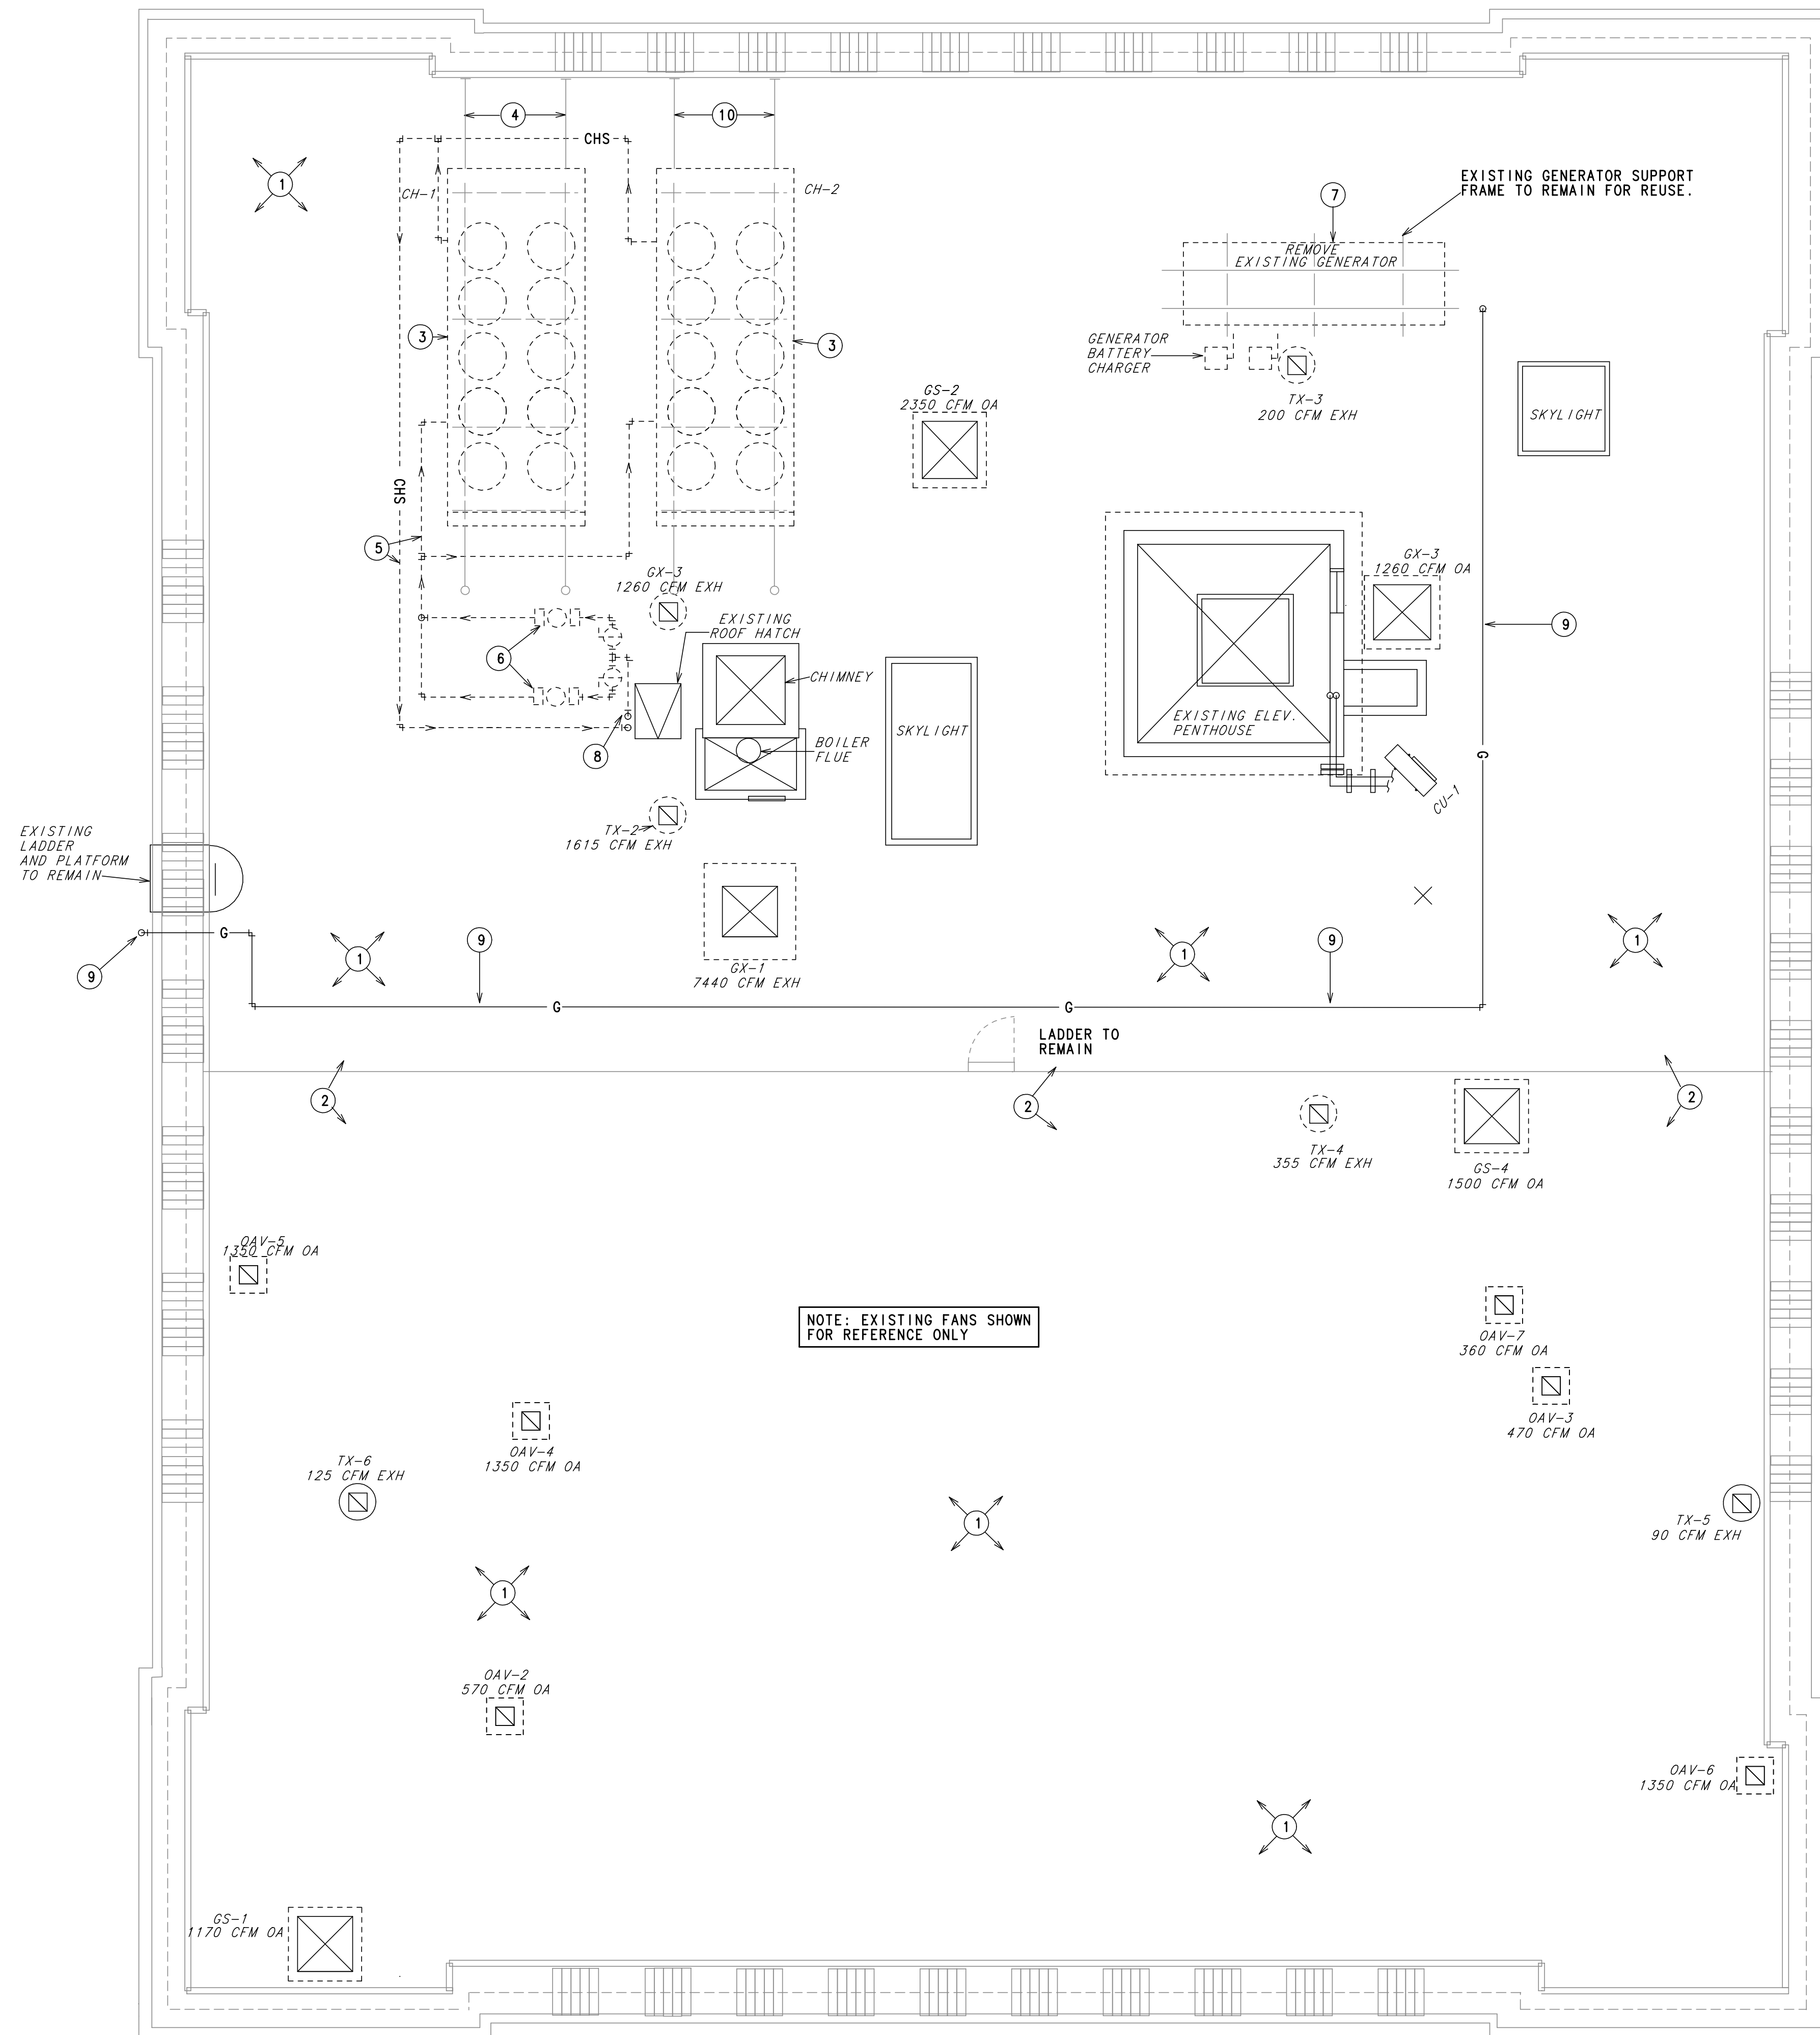
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DRAWING NAME:
MECHANICAL
DEMOLITION
FOURTH
FLOOR PLAN

JOB: 21038B
DATE: 08/31/2022
SHEET No.

M004



DEMOLITION ROOF PLAN - MECHANICAL

GRAPHIC SCALE: 3/16" = 1'-0"



- NOTES INDICATED BY "○":
- 1 ROOF REPLACEMENT IS NOT IN THE SCOPE OF THIS PROJECT. REFER TO ROOF REPLACEMENT PROJECT FOR ROOF WORK.
 - 2 NOTE THAT THE SOUTH ROOF IS APPROXIMATELY 4' HIGHER THAN THE ROOF IMMEDIATELY NORTH.
 - 3 CAREFULLY REMOVE EXISTING 110-TON AIR-COOLED PACKAGED CHILLERS (2) AND DELIVER TO OWNER AT A DESIGNATED LOCATION OF HIS CHOICE. REFER TO ELECTRICAL DRAWINGS FOR ELECTRICAL WORK. CHILLERS SHALL REMAIN IN PLACE UNTIL NEW CHILLERS ARE OPERATIONAL. SCHEDULE SHUTDOWN FOR CHANGE OVER.
 - 4 EXISTING SUPPORT FRAME FOR CHILLERS TO REMAIN AND BE MODIFIED TO SUPPORT NEW DOAS UNIT(S)
 - 5 REMOVE EXISTING 6" CHS/R AND SUPPORTS FROM ROOF.
 - 6 REMOVE EXISTING CHILLED WATER PUMPS MOUNTED ON ROOF. REMOVE CONDUIT AND ELECTRICAL SERVICE TO PUMPS. REFER TO ELECTRICAL DRAWINGS.
 - 7 REMOVE EXISTING NATURAL GAS GENERATOR SET FROM THE ROOF. EXISTING SUPPORT FRAME TO REMAIN.
 - 8 REMOVE EXISTING 6" CHS/R PENETRATING ROOF PATCH OPENING WATERTIGHT.
 - 9 EXISTING 2", 2PSI GAS LINE TO REMAIN TO SERVE NEW DOAS UNITS.
 - 10 EXISTING ROOF FRAME TO BE REMOVED UNDER ROOF REPLACEMENT PROJECT.


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	DATE	ISSUE FOR BIDS
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1	08/31/2022	

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DRAWING NAME:
MECHANICAL DEMOLITION
ROOF PLAN


JOB: 21038B
DATE: 08/31/2022
SHEET No.

M005

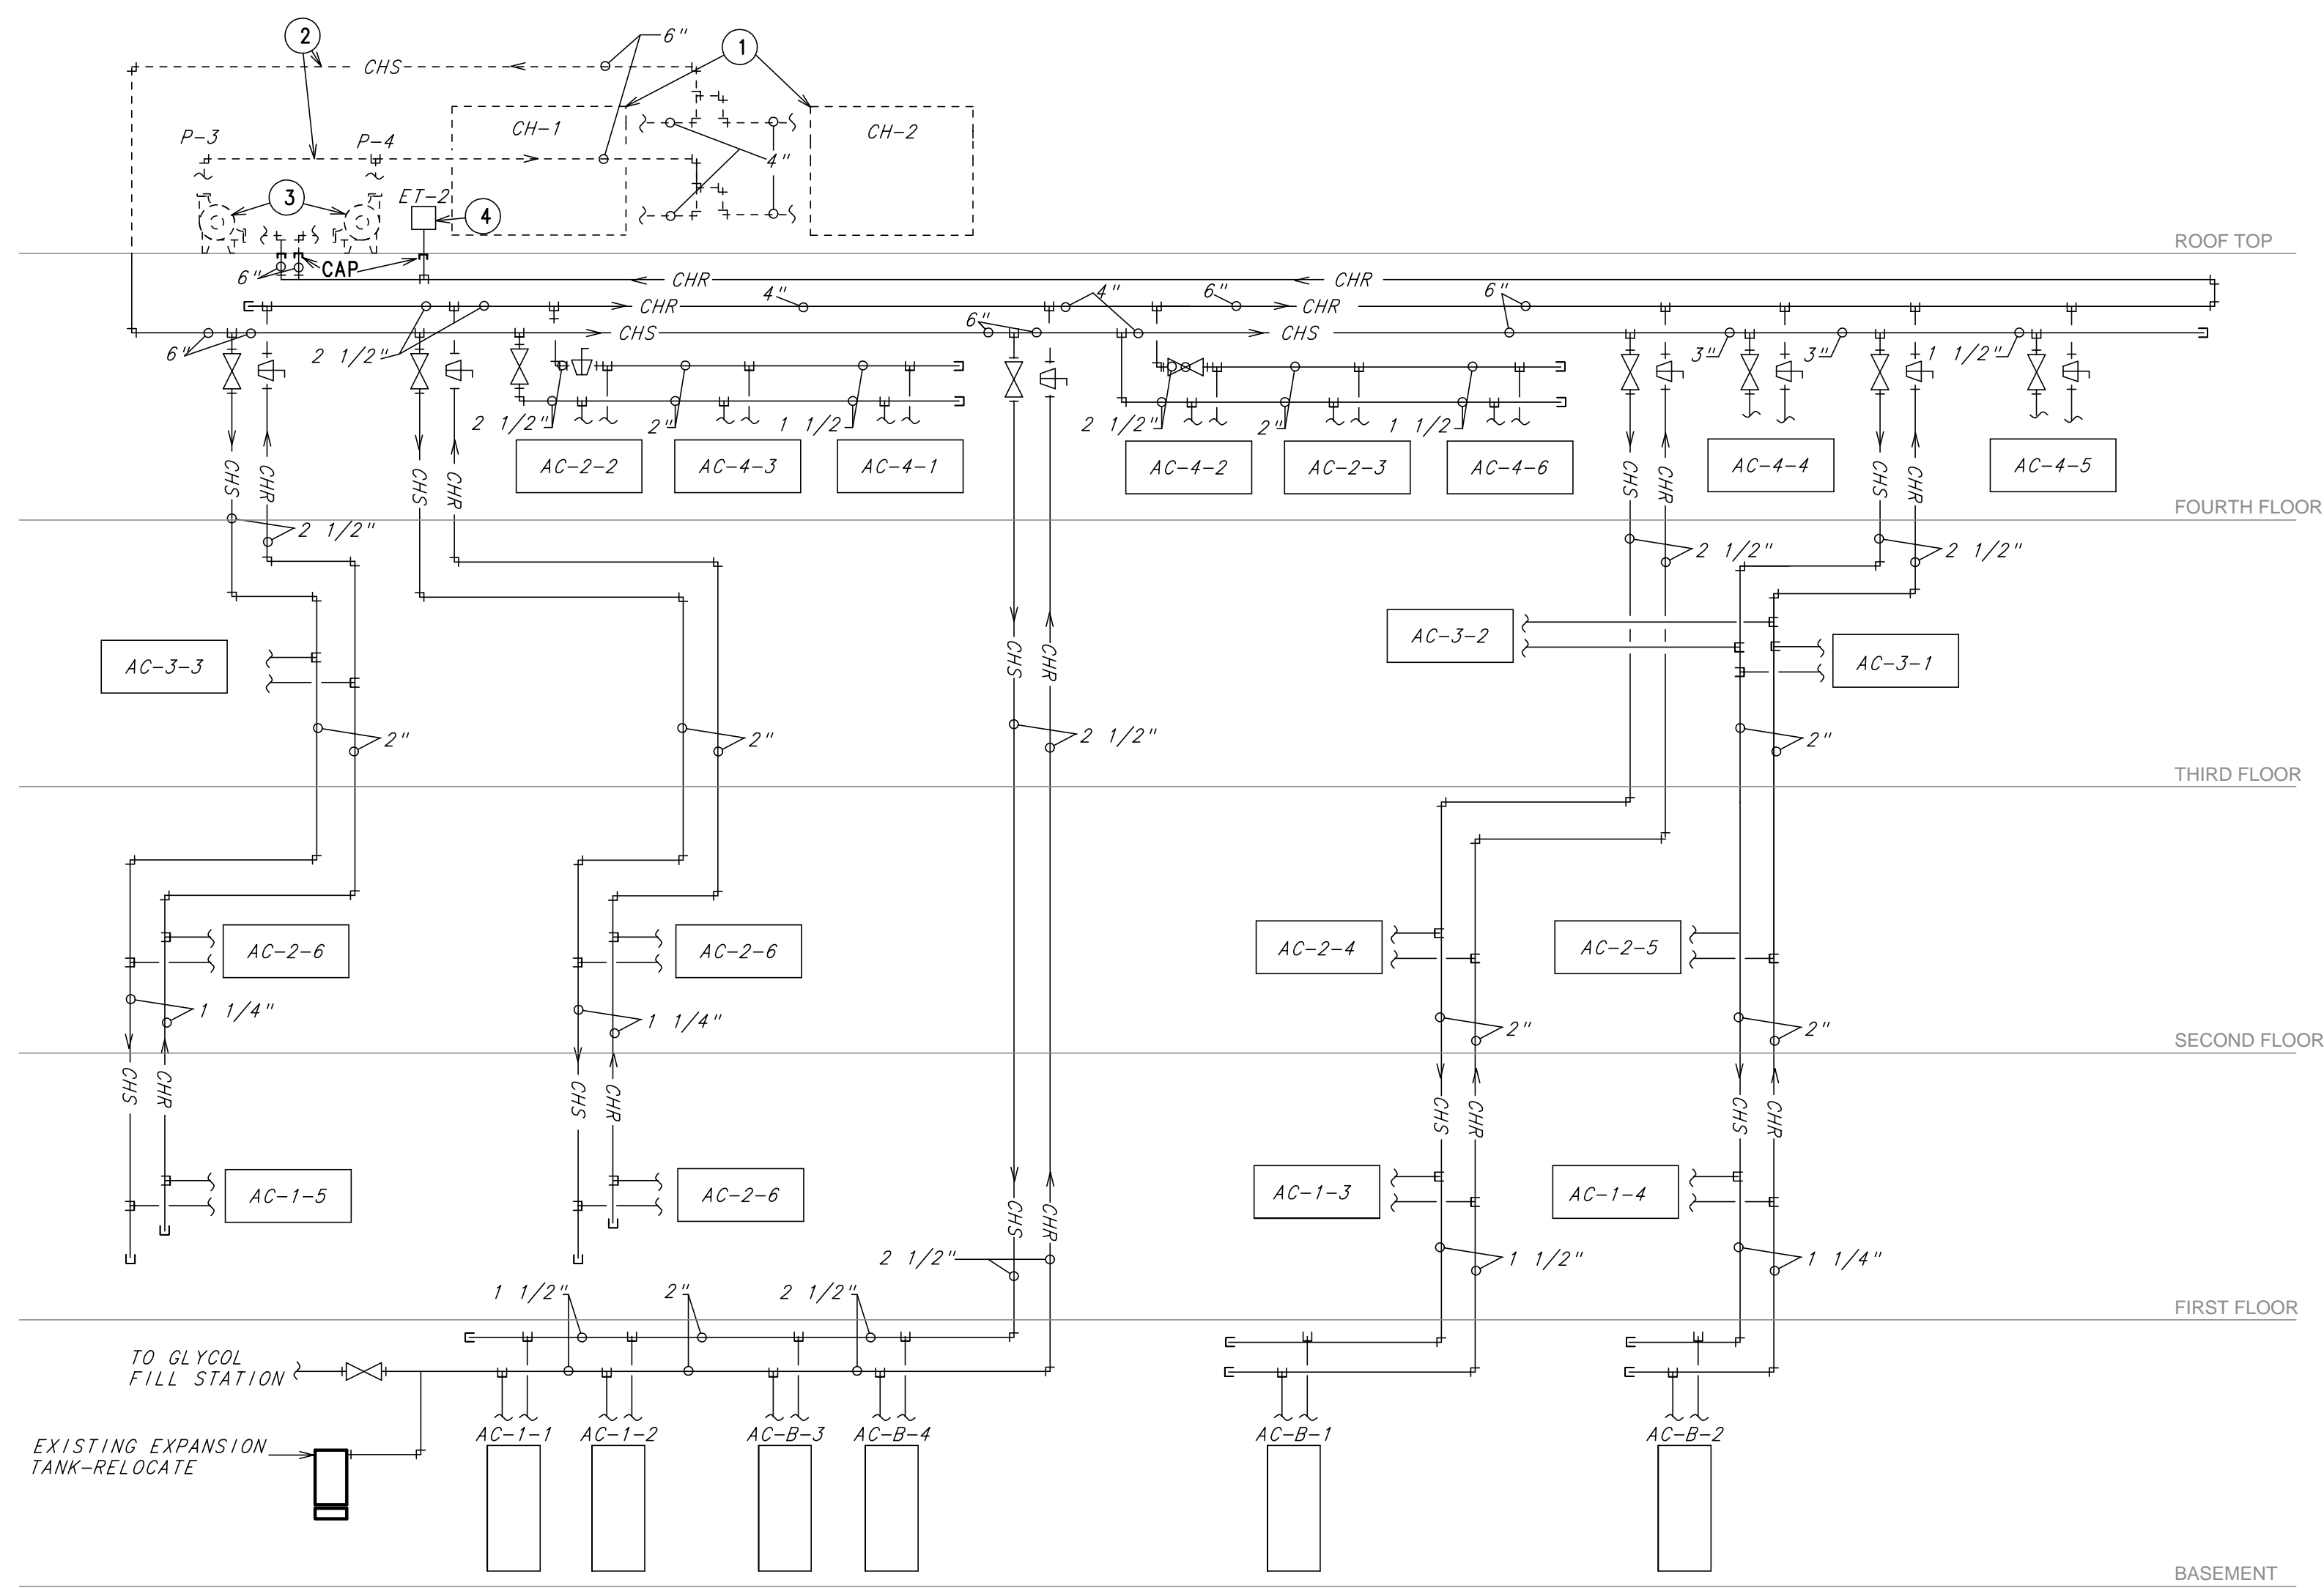

EXISTING CHILLED WATER PIPING DIAGRAM - DEMOLITION

NOT TO SCALE

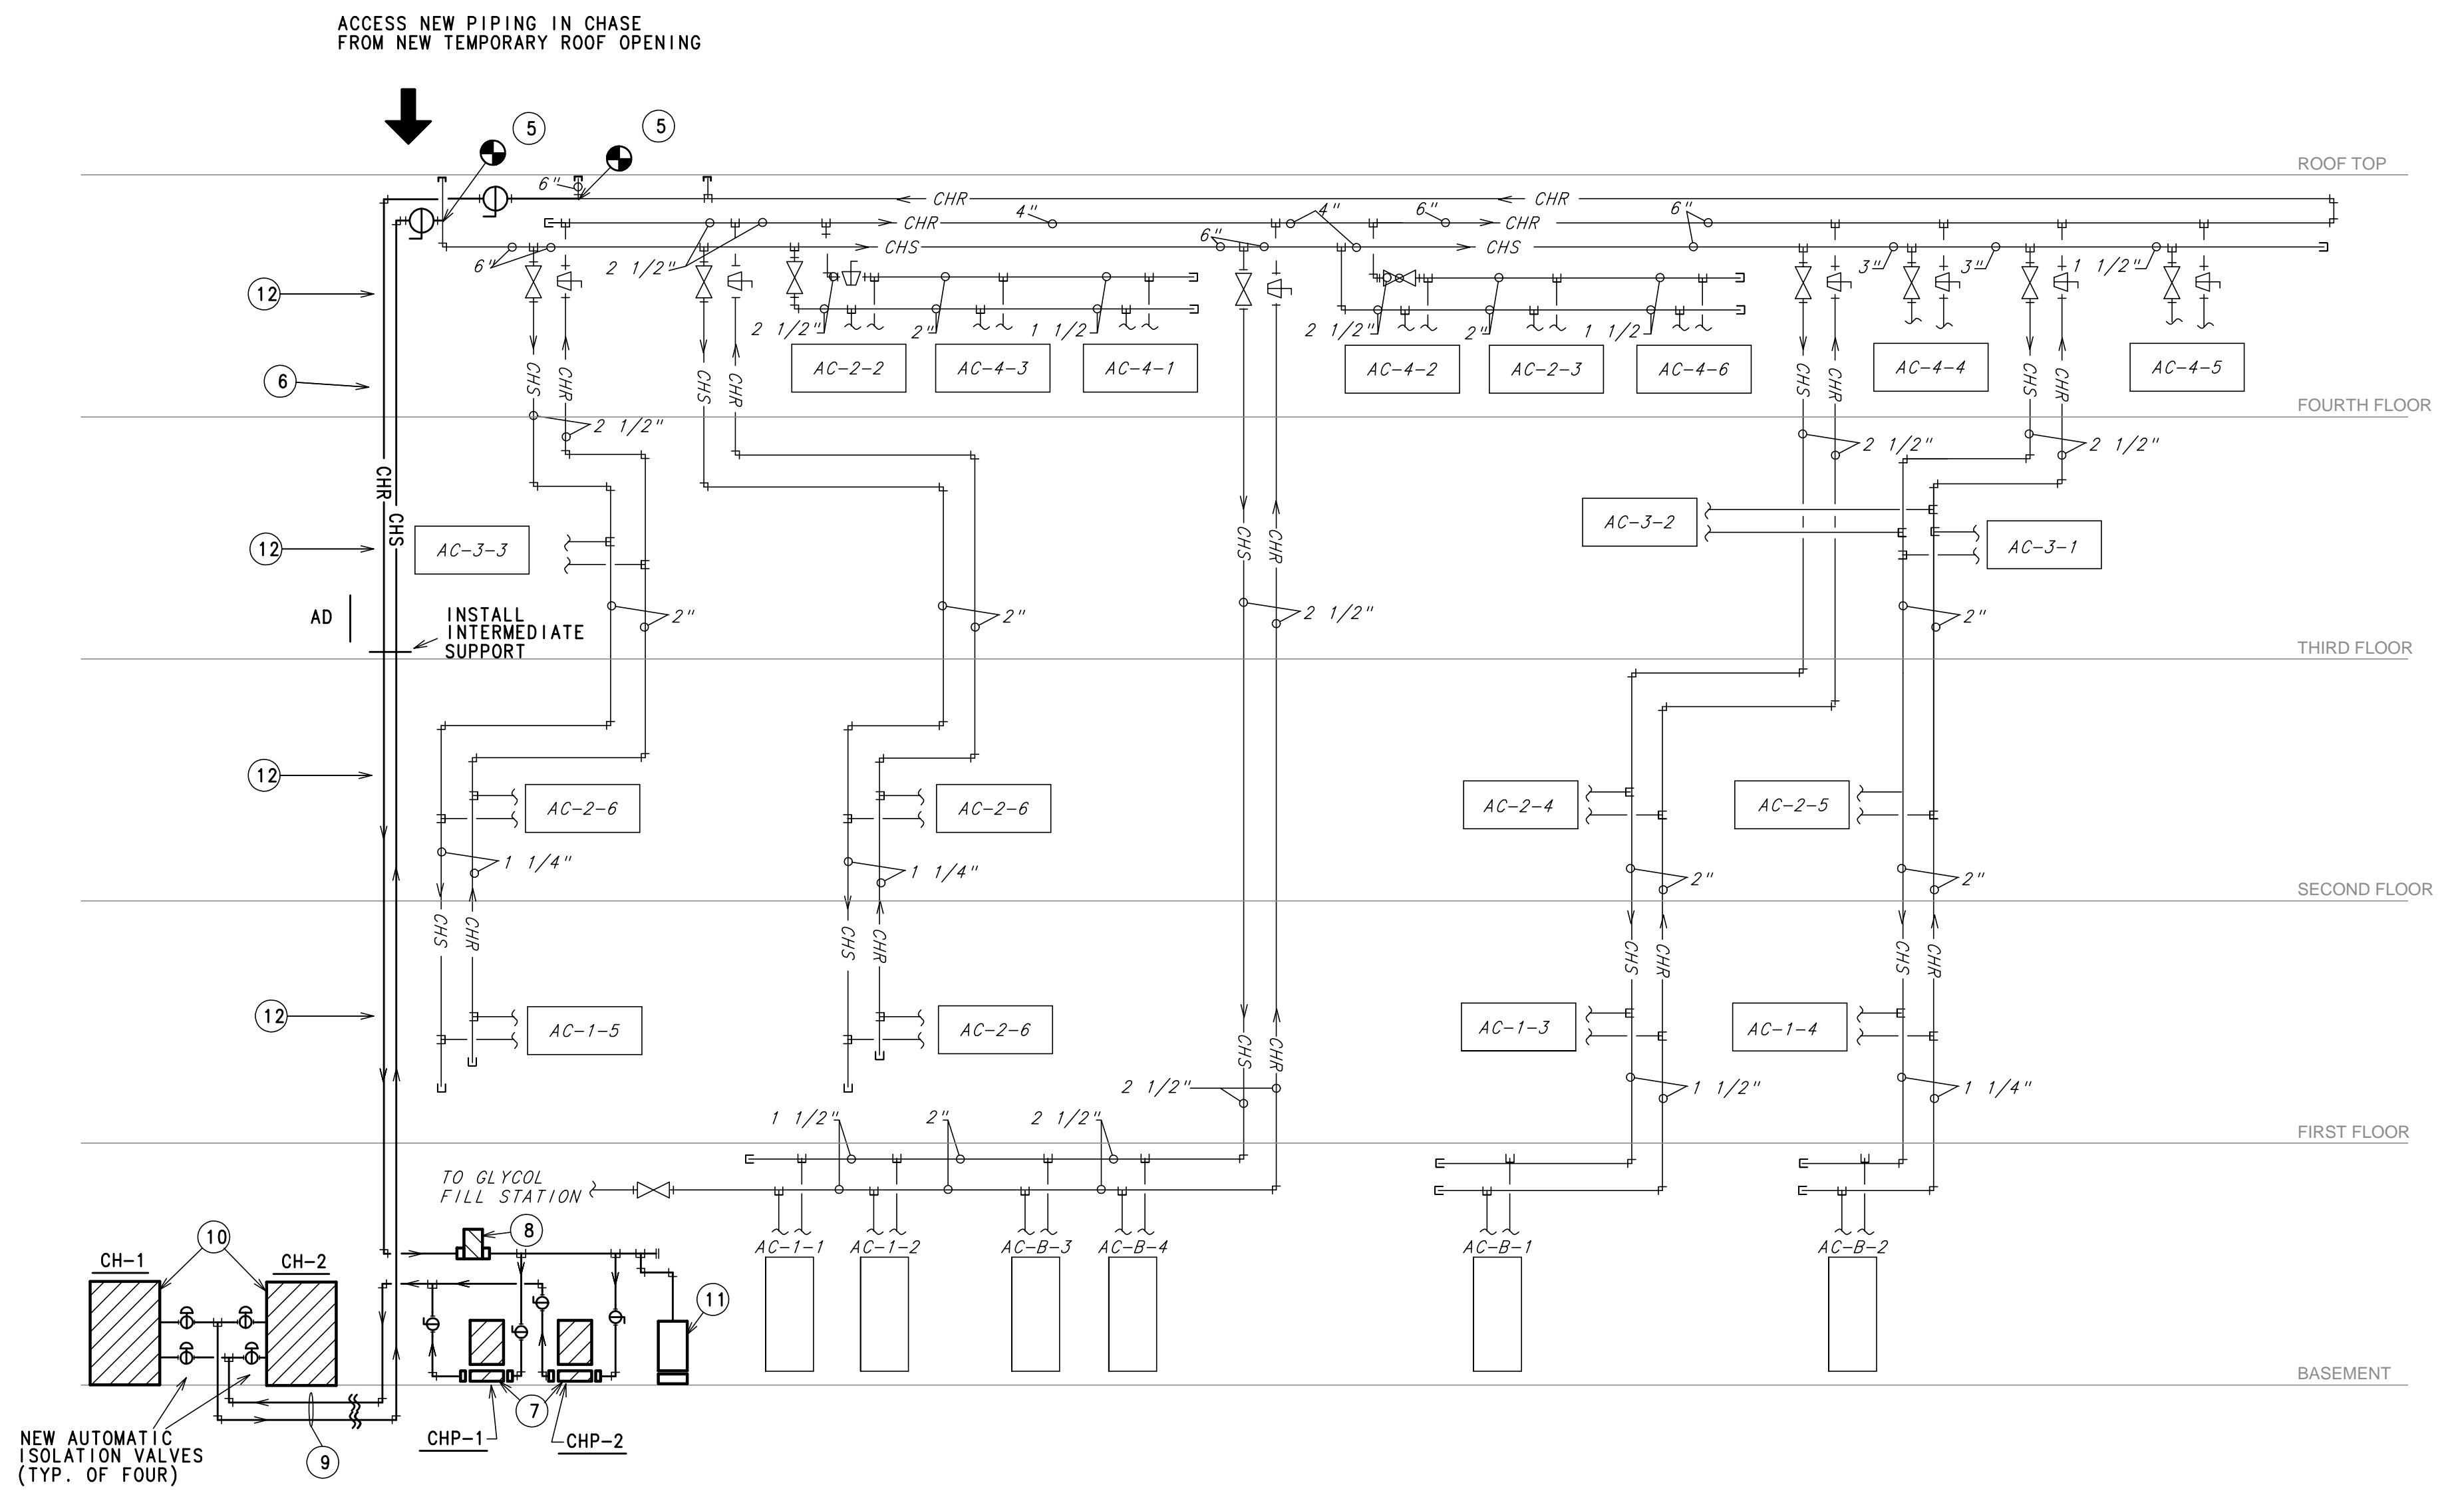


NEW CHILLED WATER PIPING DIAGRAM

NOT TO SCALE

NOTES INDICATED BY "○":

- ① REMOVE EXISTING CHILLERS FROM ROOF
- ② REMOVE ALL ROOF MOUNTED CHS/R PIPING
- ③ REMOVE EXISTING PUMPS
- ④ REMOVE EXISTING CHILLED WATER EXPANSION TANK FROM ROOF. CAP PIPING BELOW ROOF.
- ⑤ CONNECT TO EXISTING 6" CHILLED WATER PIPING AT CEILING OF 4TH FLOOR. INSTALL AVV AT HIGH POINT. ROUTE DRAIN TO NEAREST SINK.
- ⑥ EXTEND NEW 6" PIPING DOWN IN EXISTING CHASE TO MECHANICAL EQUIPMENT ROOM
- ⑦ NEW CHILLED WATER PUMP CHP-1 AND STANDBY PUMP CHP-2, BOTH WITH VFDS.
- ⑧ NEW 6" AIR SEPARATOR
- ⑨ EXTEND PIPING FROM MECHANICAL EQUIPMENT ROOM UNDERGROUND TO NEW CHILLERS NORTH OF COURTHOUSE. UTILIZE BORE MACHINE AND PRE-INSULATED PIPING AS SPECIFIED.
- ⑩ NEW NOM. 100-TON AIR COOLED PACKAGED CHILLERS ON CONCRETE PADS IN PARKING LOT WITH CHAIN-LINK FENCE SURROUNDING - REFER TO SITE PLAN.
- ⑪ RELOCATED EXPANSION TANK.
- ⑫ CUT NEW ACCESS DOORS AT EACH FLOOR IF REQUIRED TO FACILITATE INSTALLATION OF NEW 6" CHS+R FROM ROOF. EXISTING ACCESS DOOR EXISTS AT THIRD FLOOR.

M100

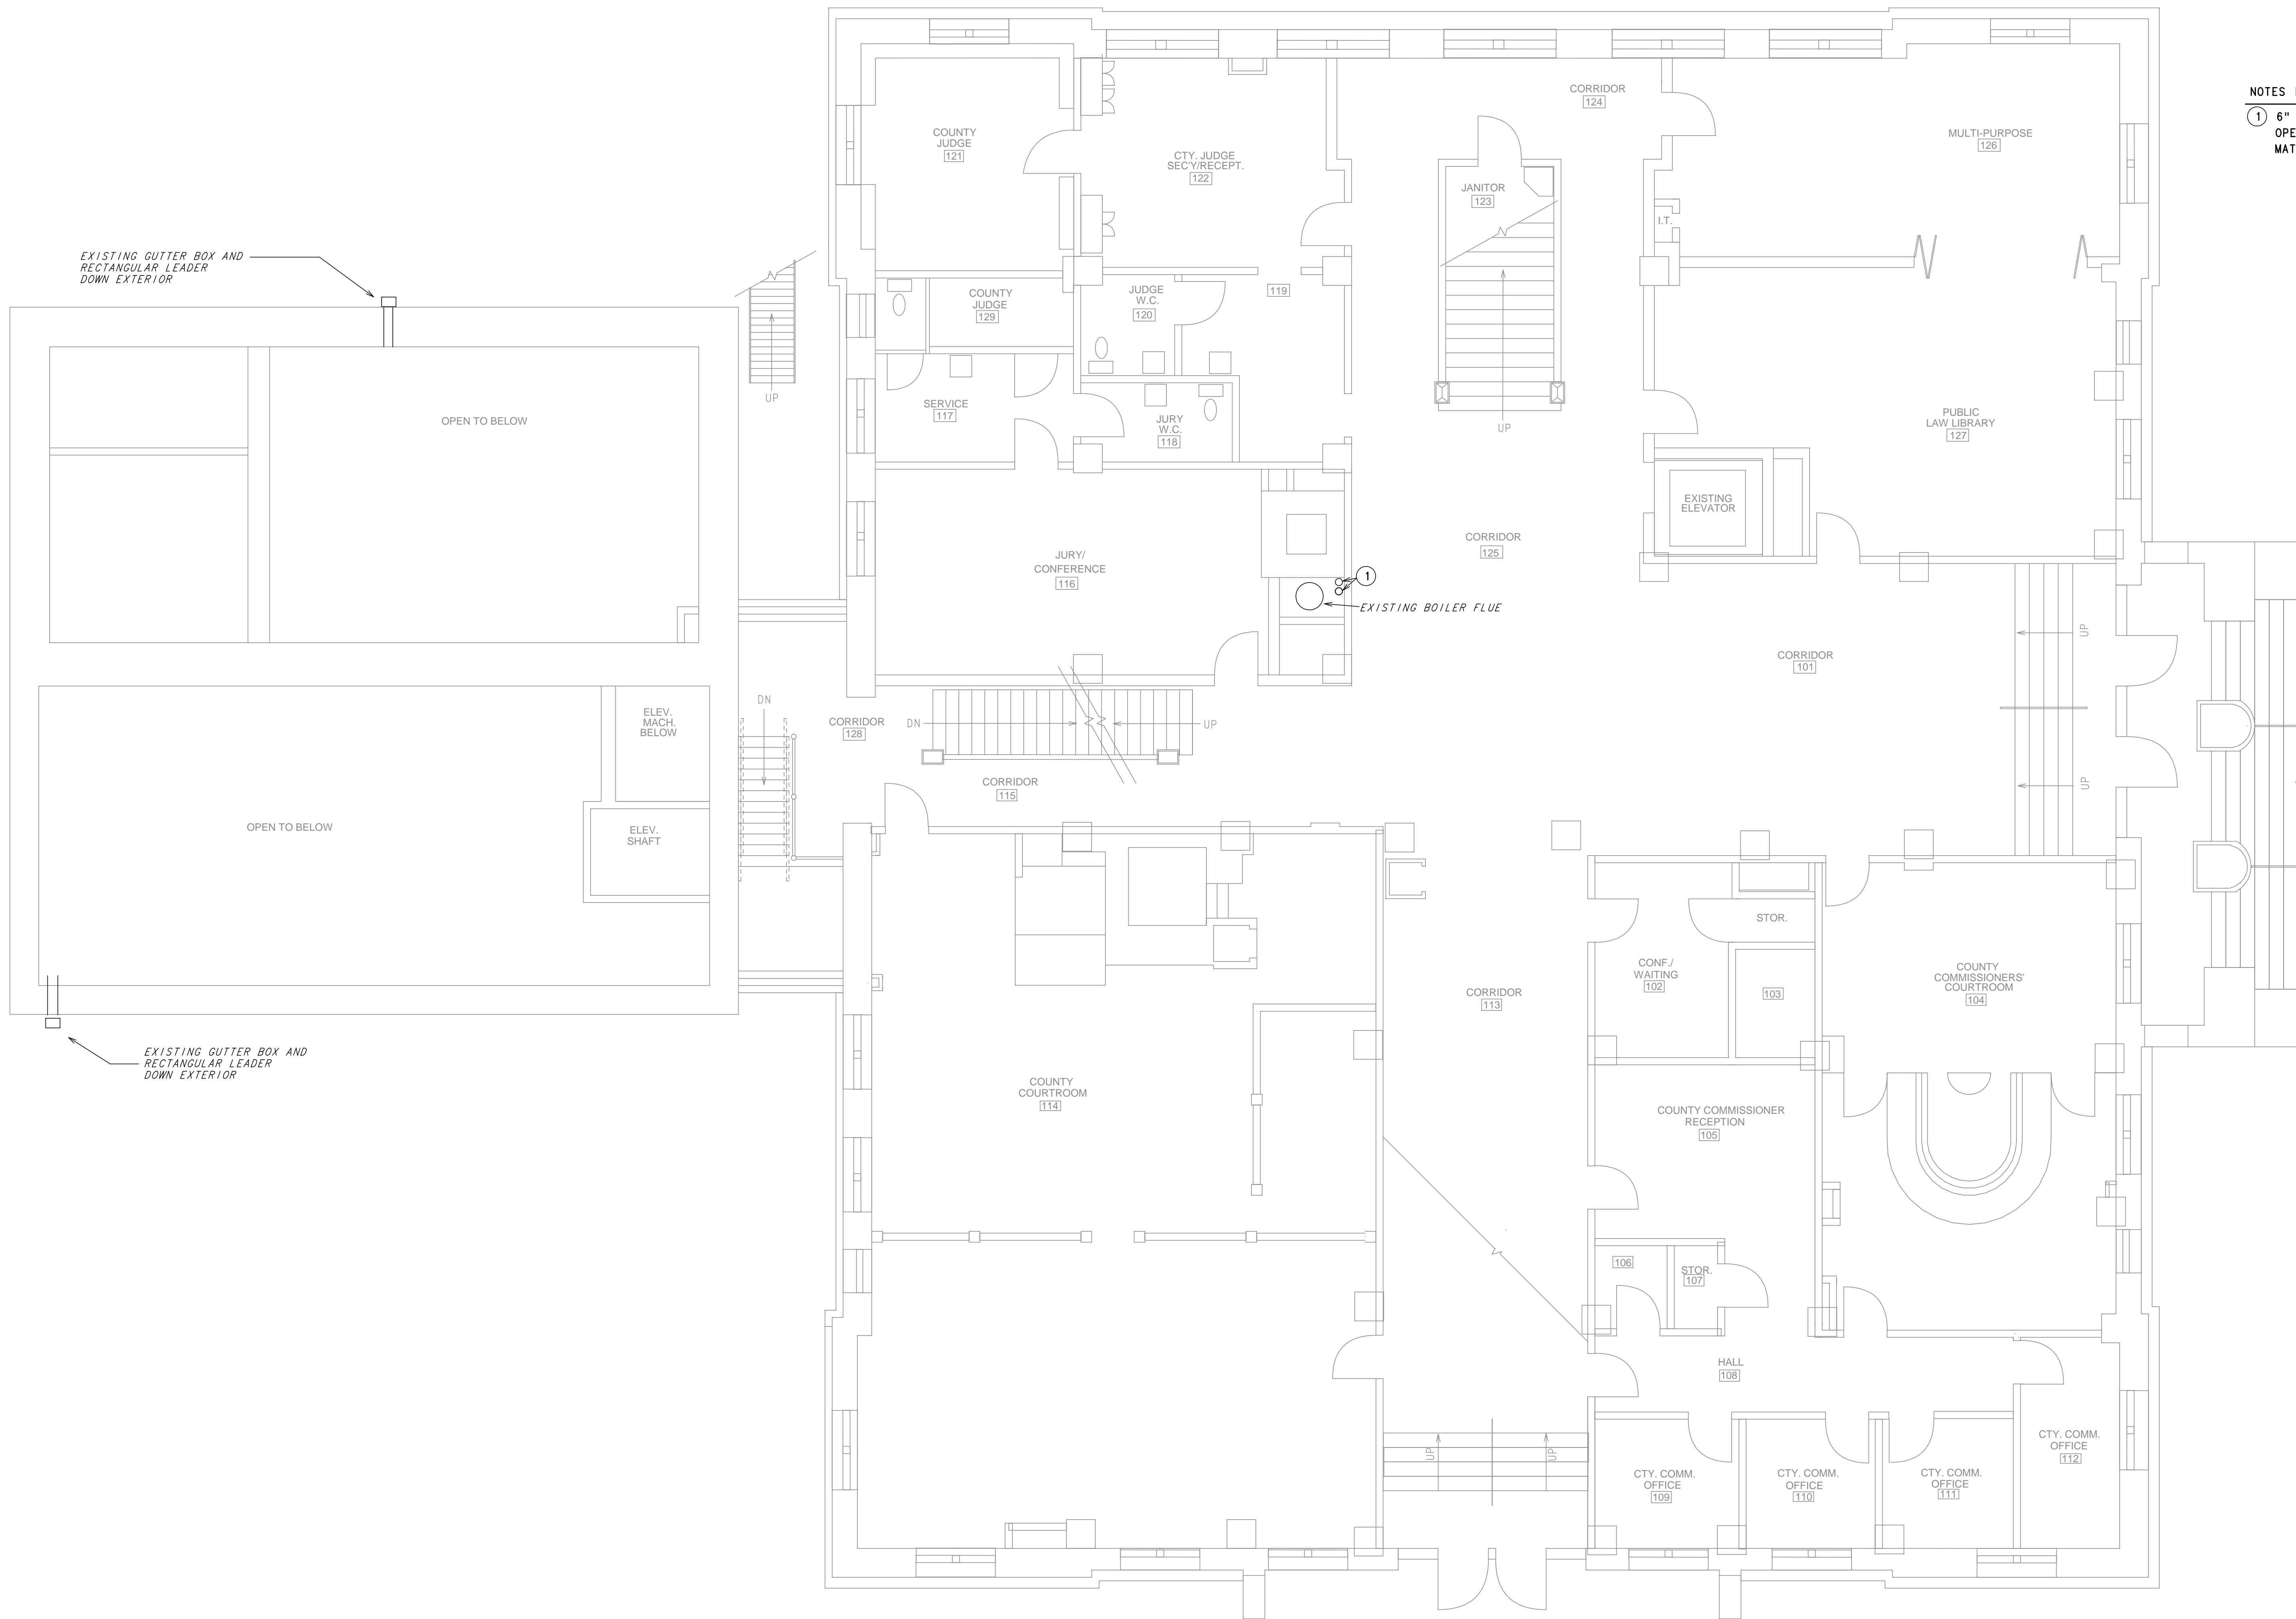


NOTES INDICATED BY "O":
① 6" CHILLED WATER SUPPLY AND RETURN UP IN CHASE TO 4TH FLOOR CEILING. INSTALL RISER BY OPENING ROOF AND CHASE ON THIRD FLOOR. PATCH ALL GENERAL CONSTRUCTION TO MATCH EXISTING SUBSEQUENT TO WORK.

NEW 1ST FLOOR PLAN - MECHANICAL

GRAPHIC SCALE: 3/16" = 1'-0"



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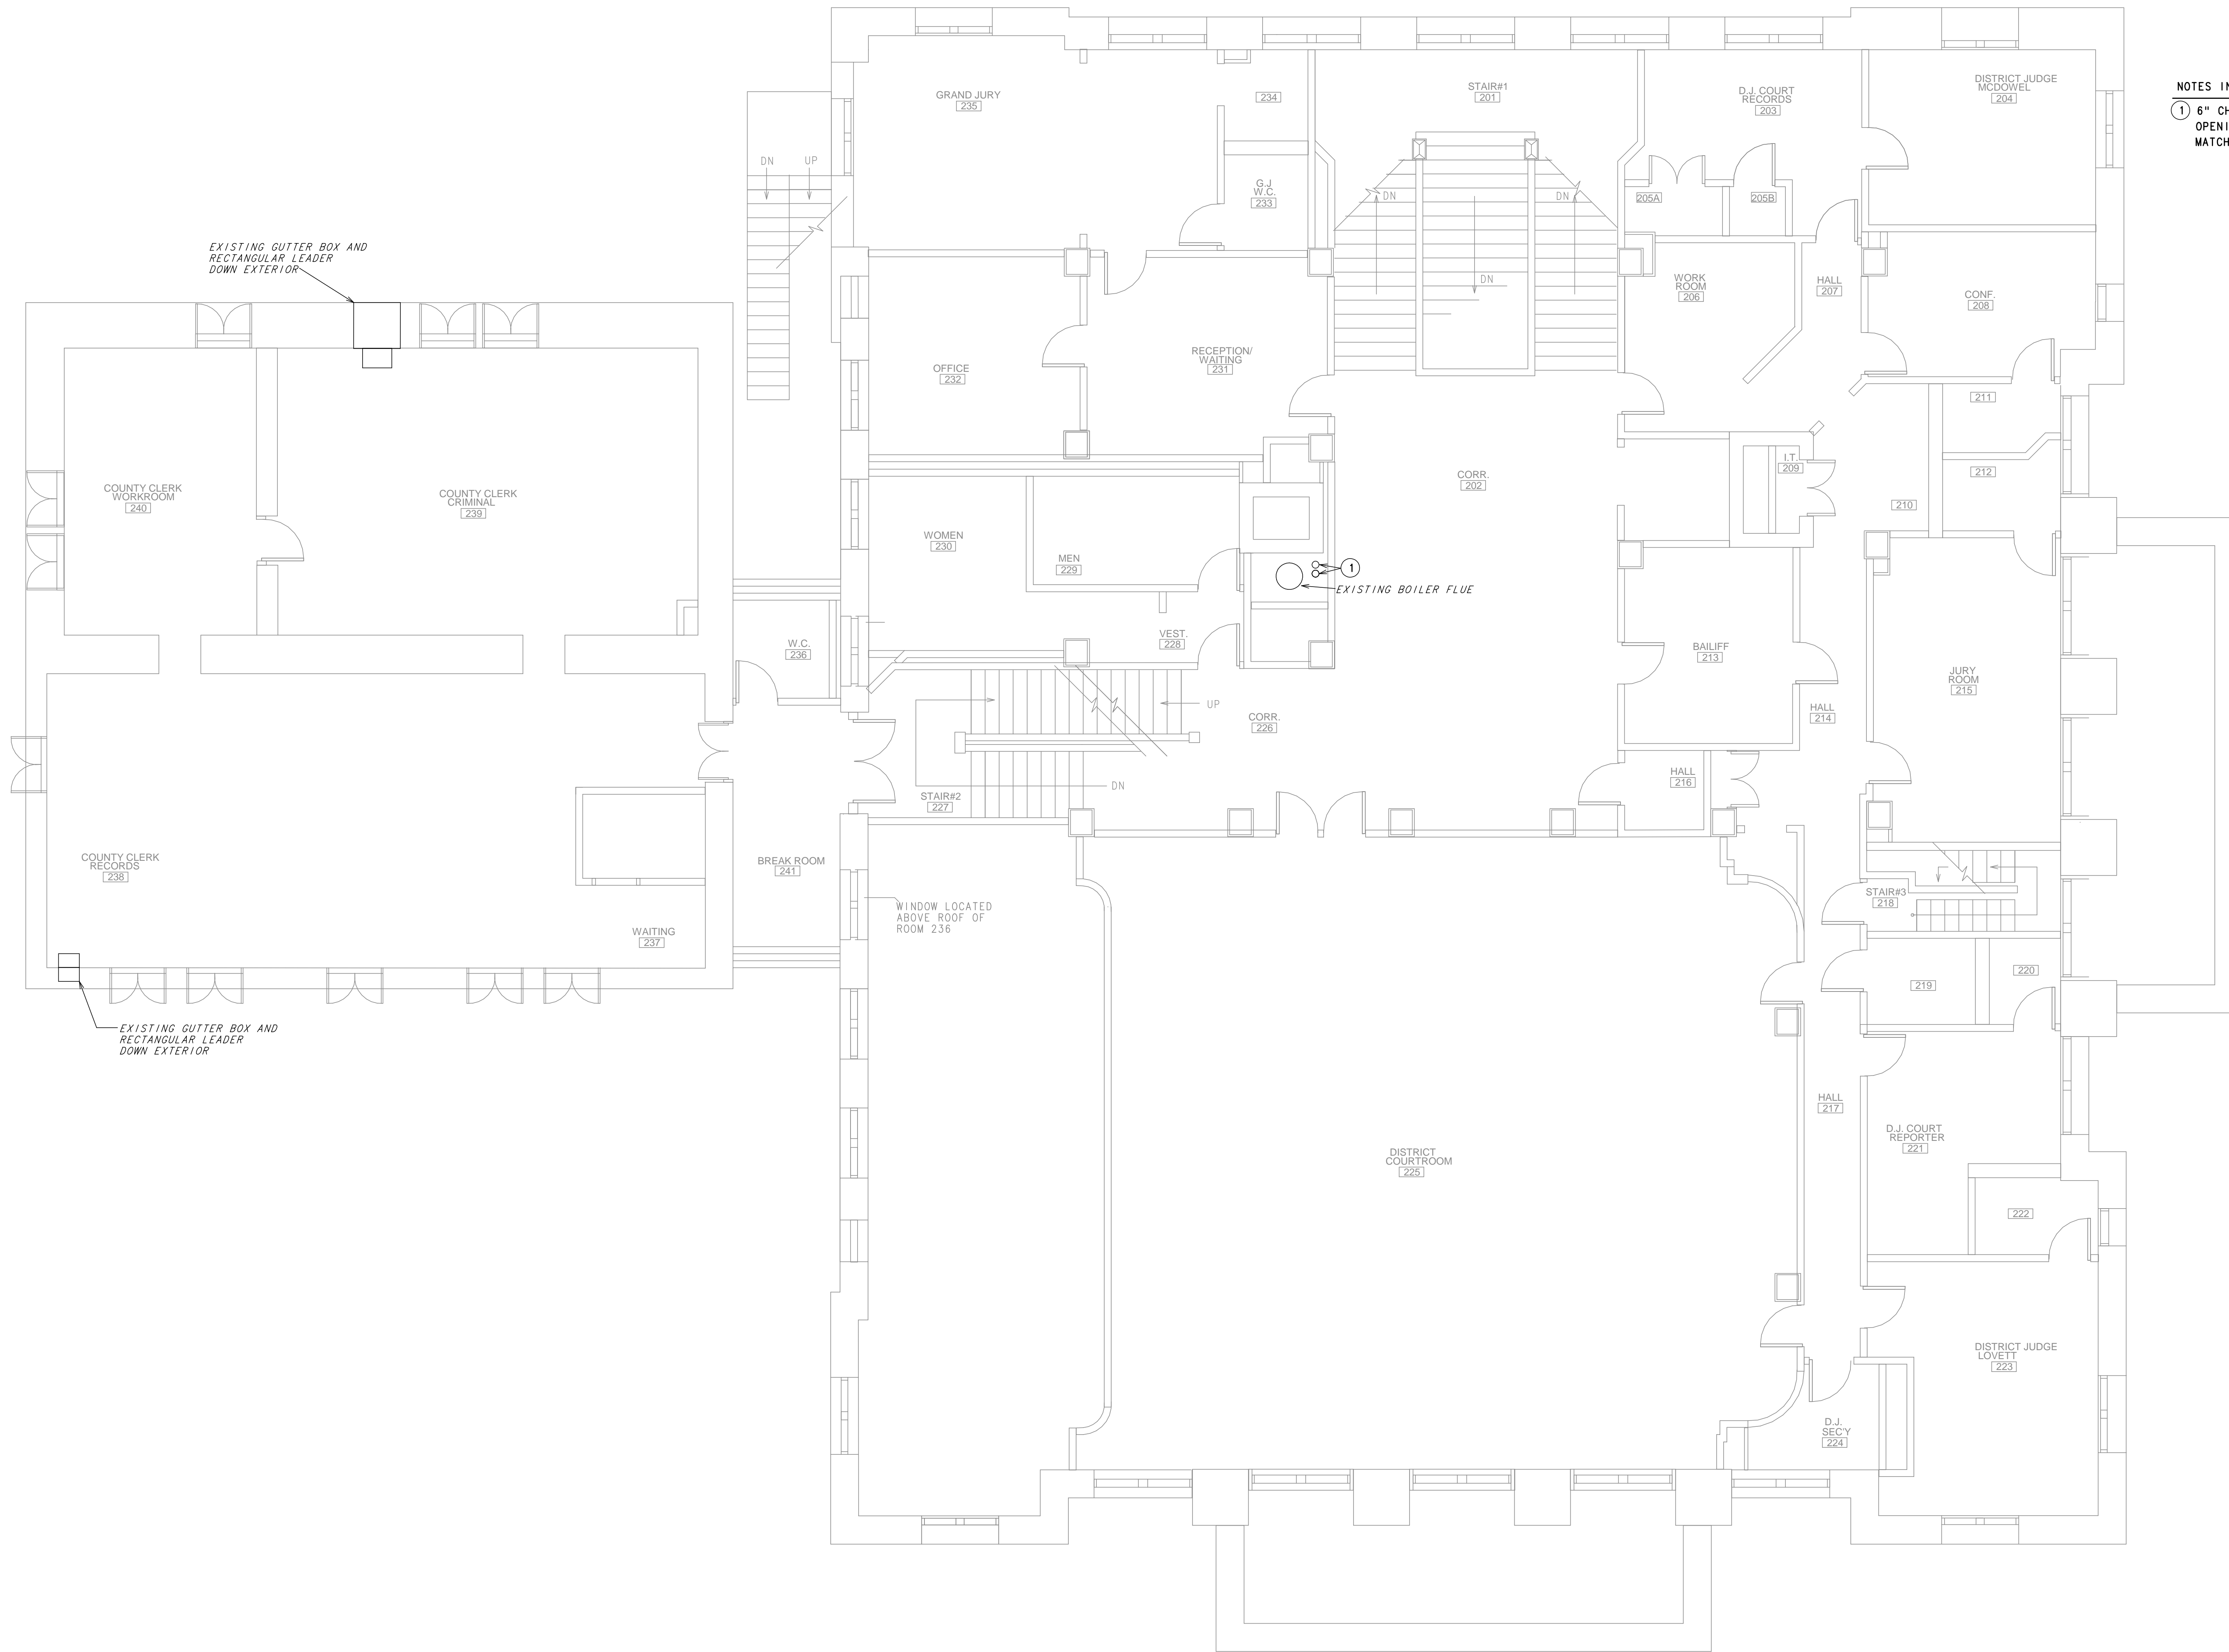
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DRAWING NAME:
MECHANICAL
NEW FIRST
FLOOR PLAN

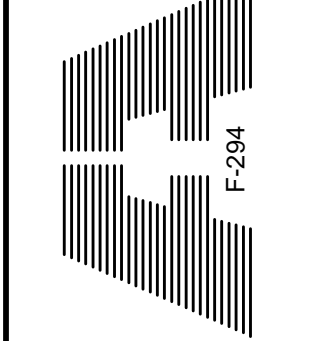
JOB: 21038B
DATE: 08/31/2022
SHEET No.

M101



NOTES INDICATED BY "○":
① 6" CHILLED WATER SUPPLY AND RETURN UP IN CHASE TO 4TH FLOOR CEILING. INSTALL RISER BY OPENING ROOF AND CHASES ON EACH FLOOR AS REQUIRED. PATCH ALL GENERAL CONSTRUCTION TO MATCH EXISTING SUBSEQUENT TO WORK.

NEW 2ND FLOOR PLAN - MECHANICAL

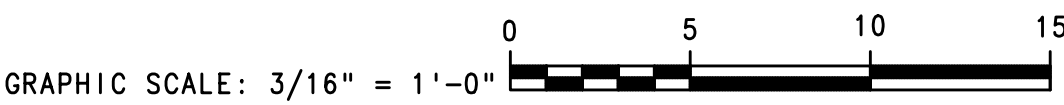


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MECHANICAL
NEW SECOND
FLOOR PLAN

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NOTES INDICATED BY "○":


① 6" CHILLED WATER SUPPLY AND RETURN UP IN CHASE TO 4TH FLOOR CEILING. INSTALL RISER BY OPENING ROOF AND CHASES ON EACH FLOOR AS REQUIRED. PATCH ALL GENERAL CONSTRUCTION TO MATCH EXISTING SUBSEQUENT TO WORK.

NEW 3RD FLOOR PLAN - MECHANICAL

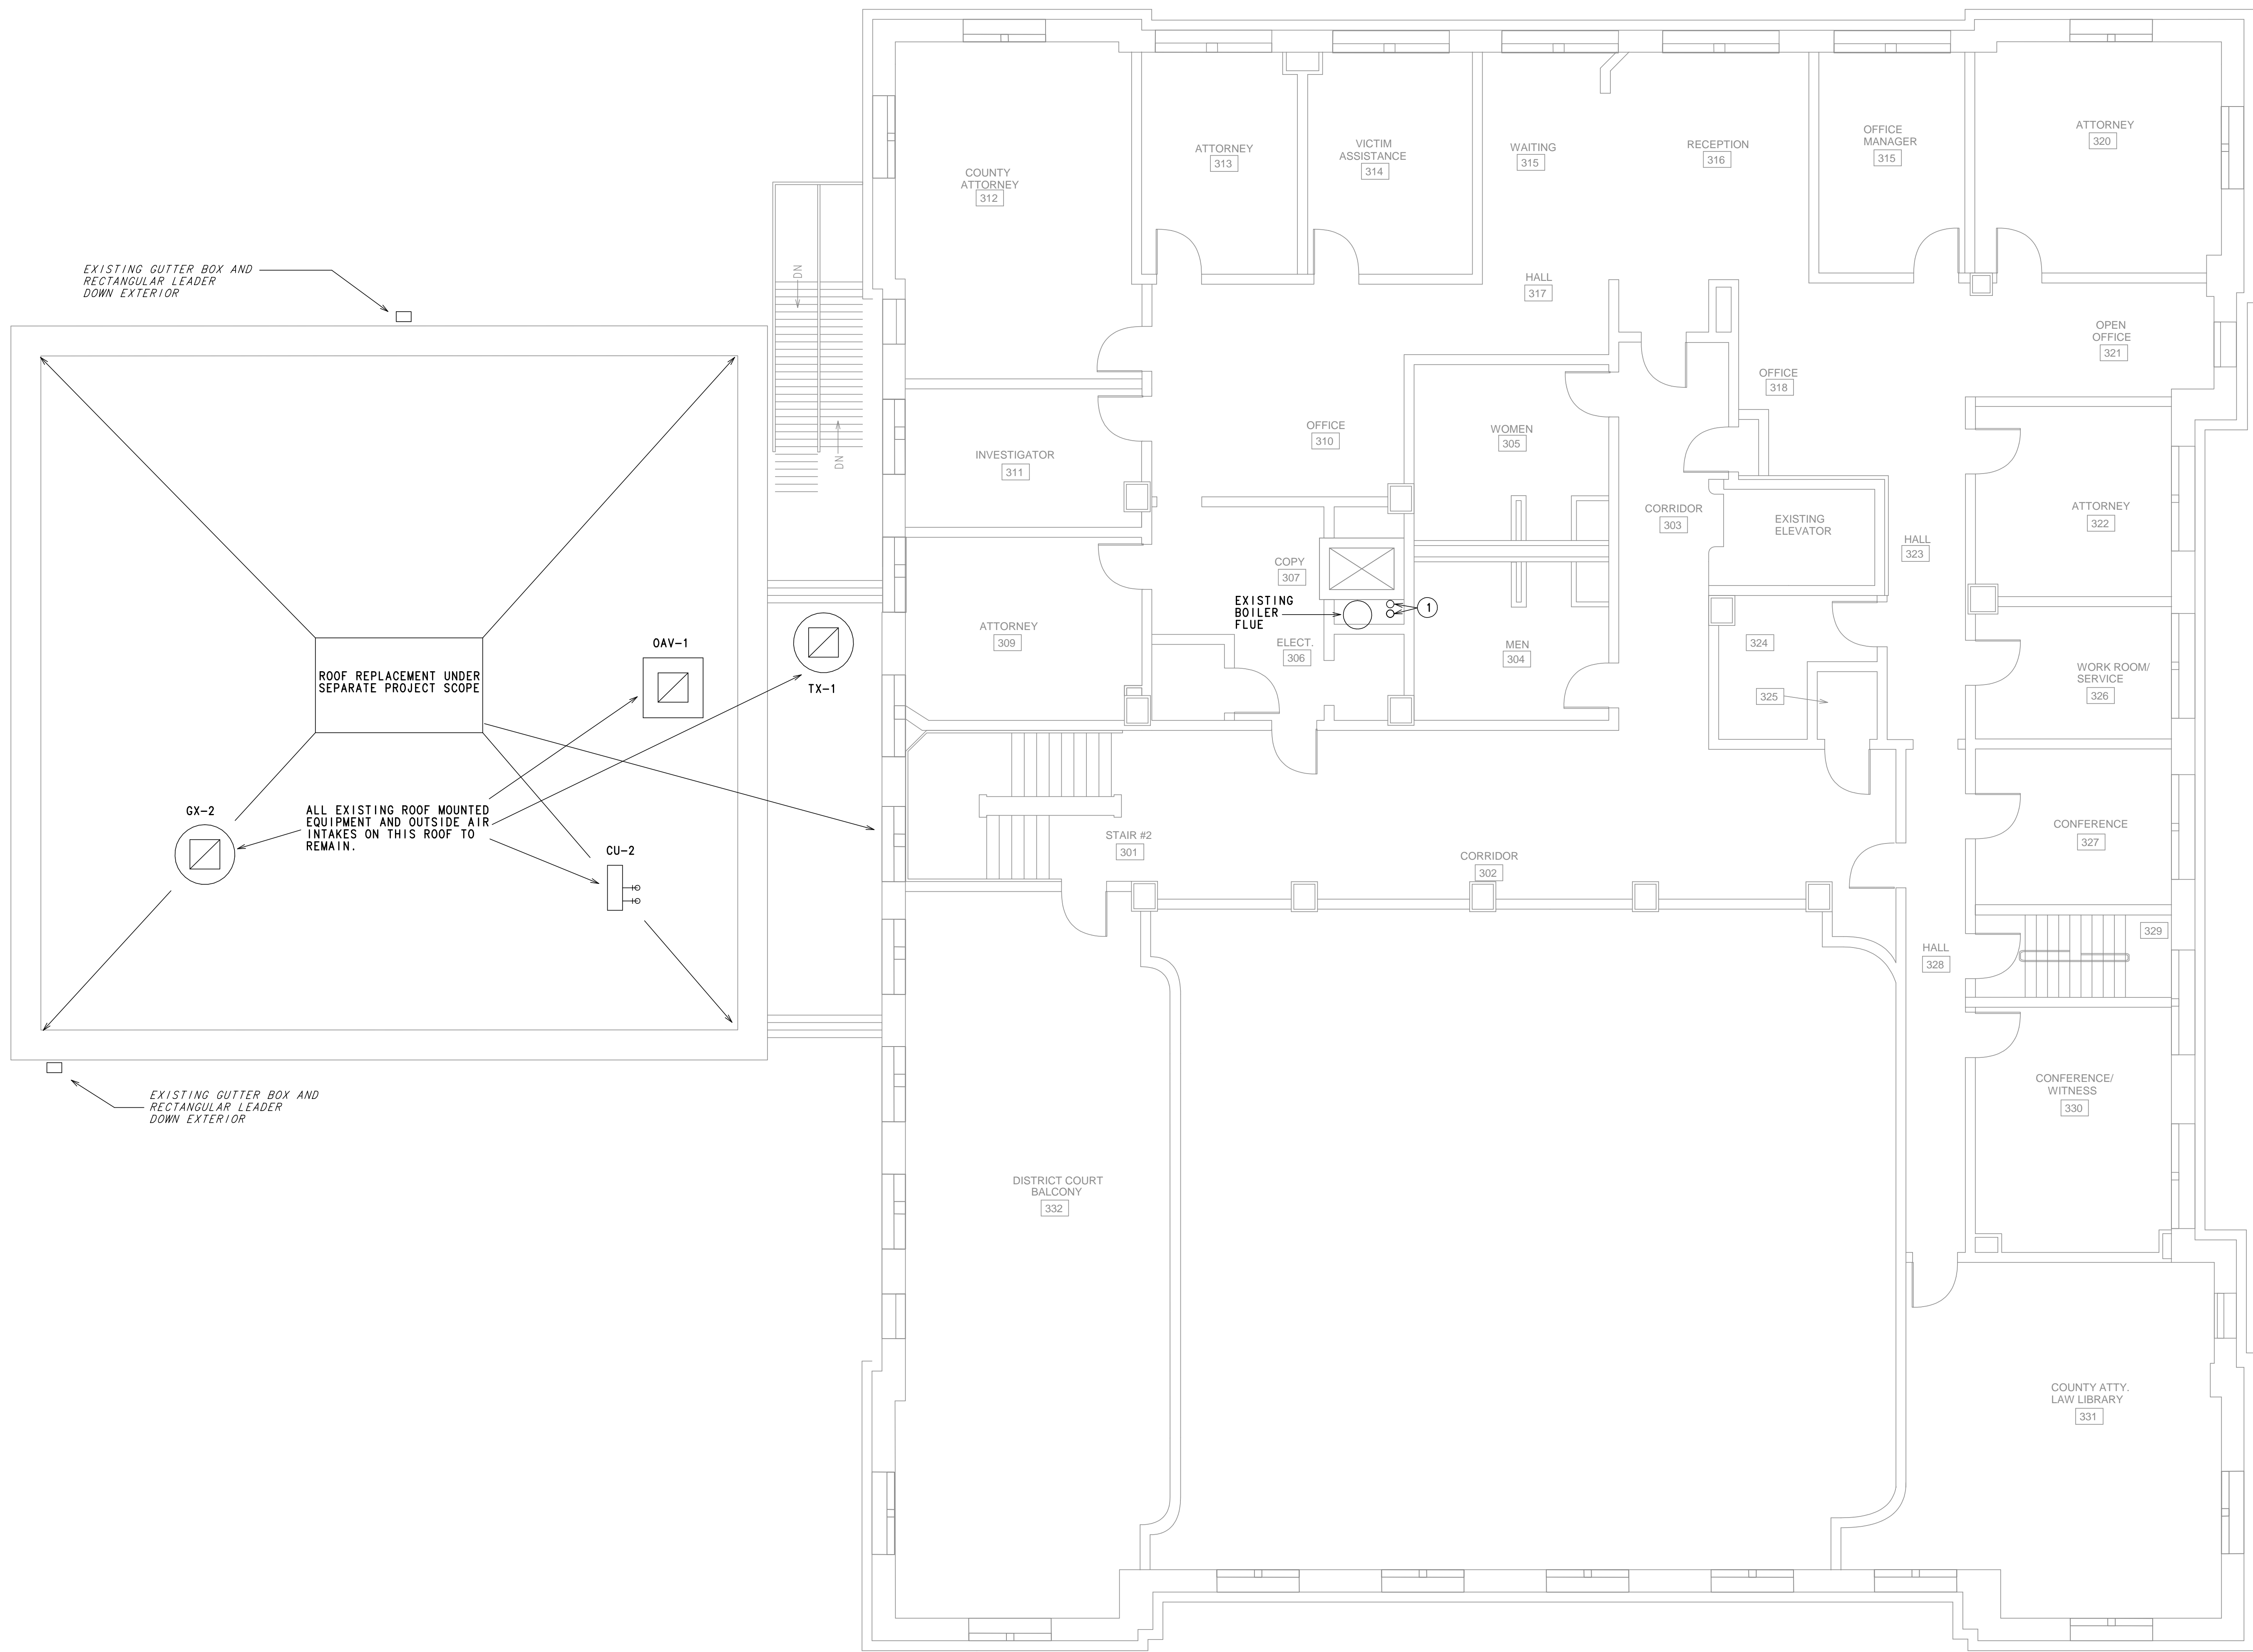GRAPHIC SCALE: 3/16" = 1'-0"



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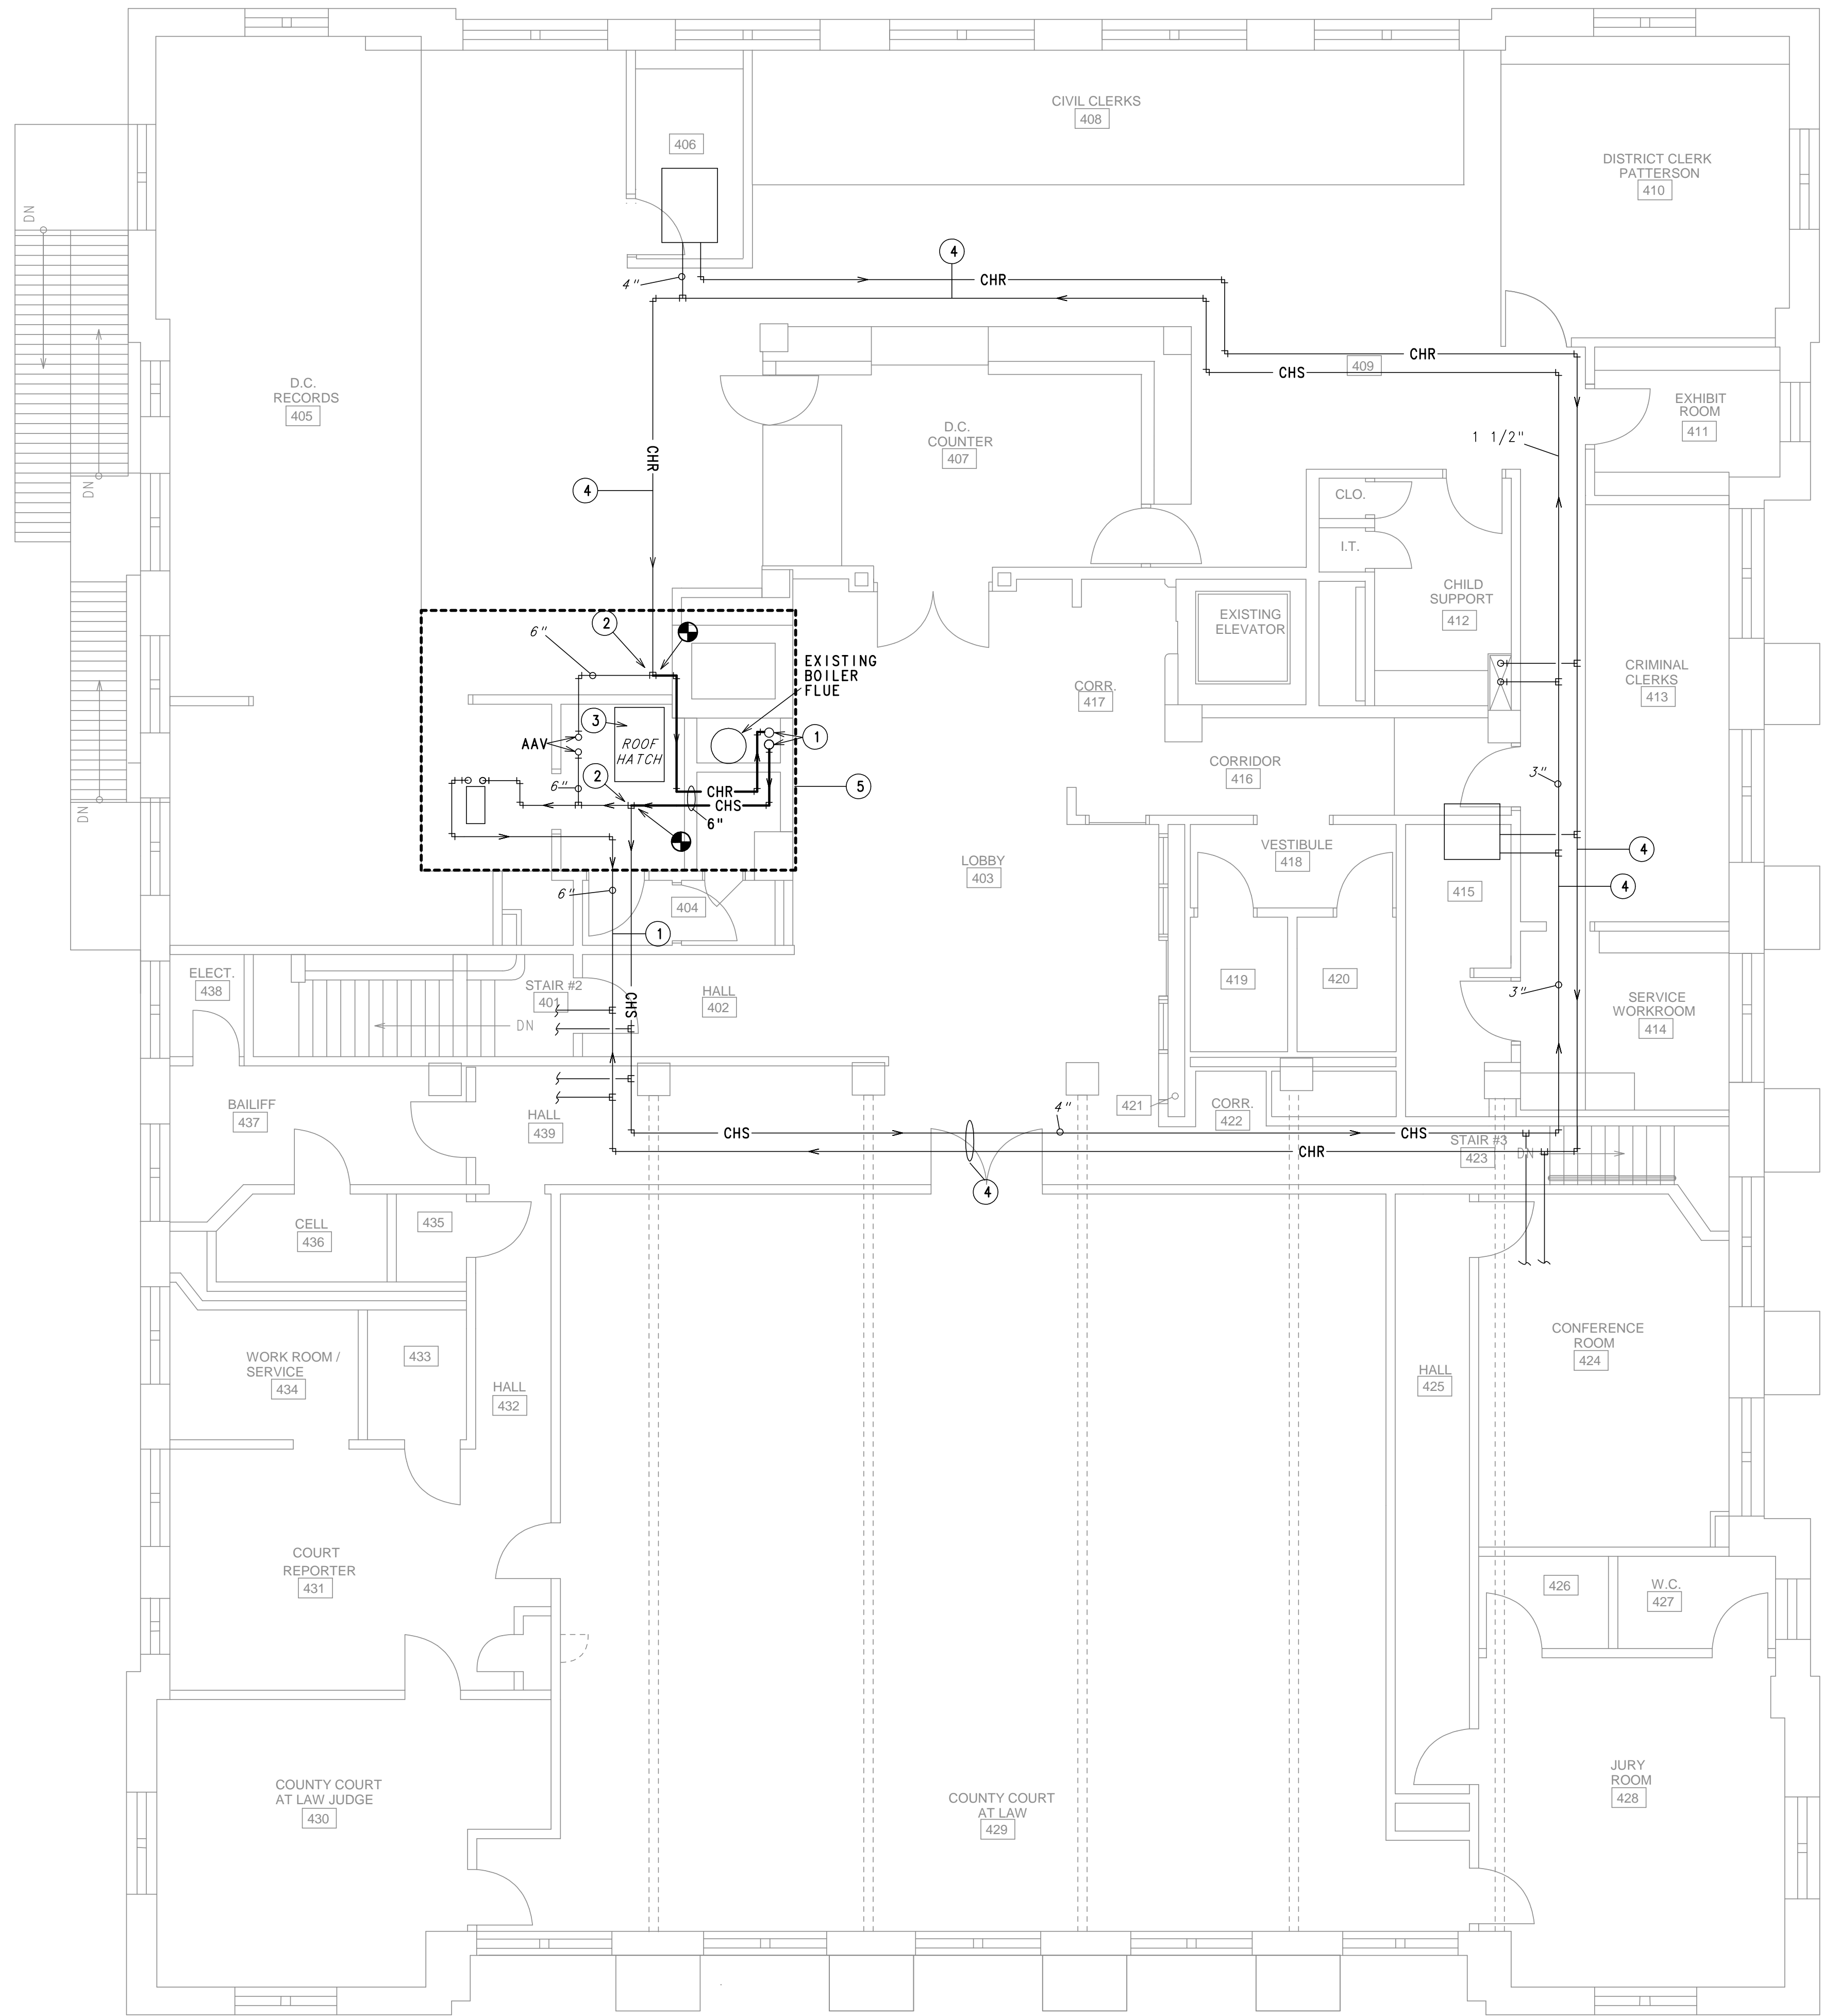
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	1	08/31/2022	ISSUE FOR BIDS
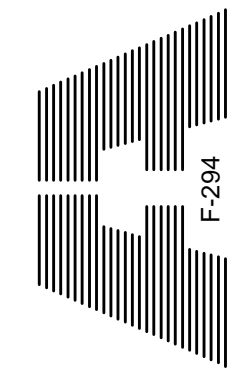
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DRAWING NAME:
MECHANICAL
NEW THIRD
FLOOR PLAN

JOB: 21038B
DATE: 08/31/2022
SHEET No.

M103




- NOTES INDICATED BY "○":
- 6" CHILLED WATER SUPPLY AND RETURN UP IN CHASE TO 4TH FLOOR CEILING. INSTALL RISER BY OPENING ROOF AND CHASES ON EACH FLOOR AS REQUIRED. PATCH ALL GENERAL CONSTRUCTION TO MATCH EXISTING SUBSEQUENT TO WORK.
 - INTERCEPT 6" CHS/R BELOW CEILING. INSTALL AUTO AIR VENTS ON TOPS OF RISERS. TEE 6" CHS/R AND EXTEND DOWN CHASE TO BASEMENT MECH. ROOM.
 - EXISTING ROOF HATCH TO REMAIN.
 - EXISTING CHILLED WATER LOOP PIPING TO REMAIN IN CEILING.
 - REPLACE OR MODIFY EXISTING CEILING AS REQUIRED TO INSTALL NEW PIPING. PATCH TO MATCH EXISTING.

NEW 4TH FLOOR PLAN - MECHANICAL

GRAPHIC SCALE: 3/16" = 1'-0"



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MECHANICAL
NEW FOURTH
FLOOR PLAN
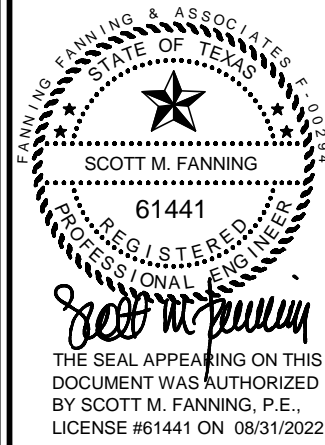
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M104

AIR COOLED PACKAGED CHILLER SCHEDULE


DESIGNATION	CAPACITY (NET TONS)	EVAPORATOR DATA				FOULING FACTOR (HR-SOFT-F/BTU)	REFRIGERANT CIRCUITS	EER	DIMENSIONS (L X W X H, INCHES)	AMBIENT TEMP °F	ELECTRICAL DATA	UNIT KW	SCCR	MOA	MOCp	REMARKS-YORK
		EWI	LWT	GPM	MAX. P.D. FT. WTR.											
CH-1	87.23	53	43.0	206	14.7	0.0001	2-R410A	8.01	143 X 88 X 94	105	460V/3PH/60HZ	130.5	5 KA	225	250	YLAA0100SE46 NOMINAL 100 TON
CH-2	87.23	53	43.0	206	14.7	0.0001	2-R410A	8.01	143 X 88 X 94	105	460V/3PH/60HZ	130.5	5 KA	225	250	YLAA0100SE46 NOMINAL 100 TON

- NOTES:
- SINGLE POINT POWER
 - CIRCUIT BREAKER
 - CONTROL TRANSFORMER
 - LOW AMBIENT KIT
 - HOT GAS BYPASS
 - LOUVERED FULL UNIT ENCLOSURE PANELS
 - NEOPRENE ISOLATORS
 - SERVICE ISOLATION VALVES
 - BACnet (ms/lp), MODBUS, N2 FOR CONNECTION UNDER PHASE 2 PROJECT.

PUMP SCHEDULE

PUMP DESIGNATION	GPM	HEAD FT. WATER	MIN. EFF.	TYPE OF PUMP	SPEED RPM	MIN. H.P.	ELECTRICAL	REMARKS
CHP-1	415	120	69.7	VERTICAL IN-LINE	3580	20	460V/3PH/60HZ	ARMSTRONG 4300-3X3X8
CHP-2	415	120	69.7	VERTICAL IN-LINE	3580	20	460V/3PH/60HZ	ARMSTRONG 4300-3X3X8 (STANDBY)

- NOTES:
- PROVIDE EACH PUMP WITH A VARIABLE FREQUENCY DRIVE.
 - CONNECT NEW VFD TO JCI METASYS SYSTEM UNDER PHASE 2 PROJECT.

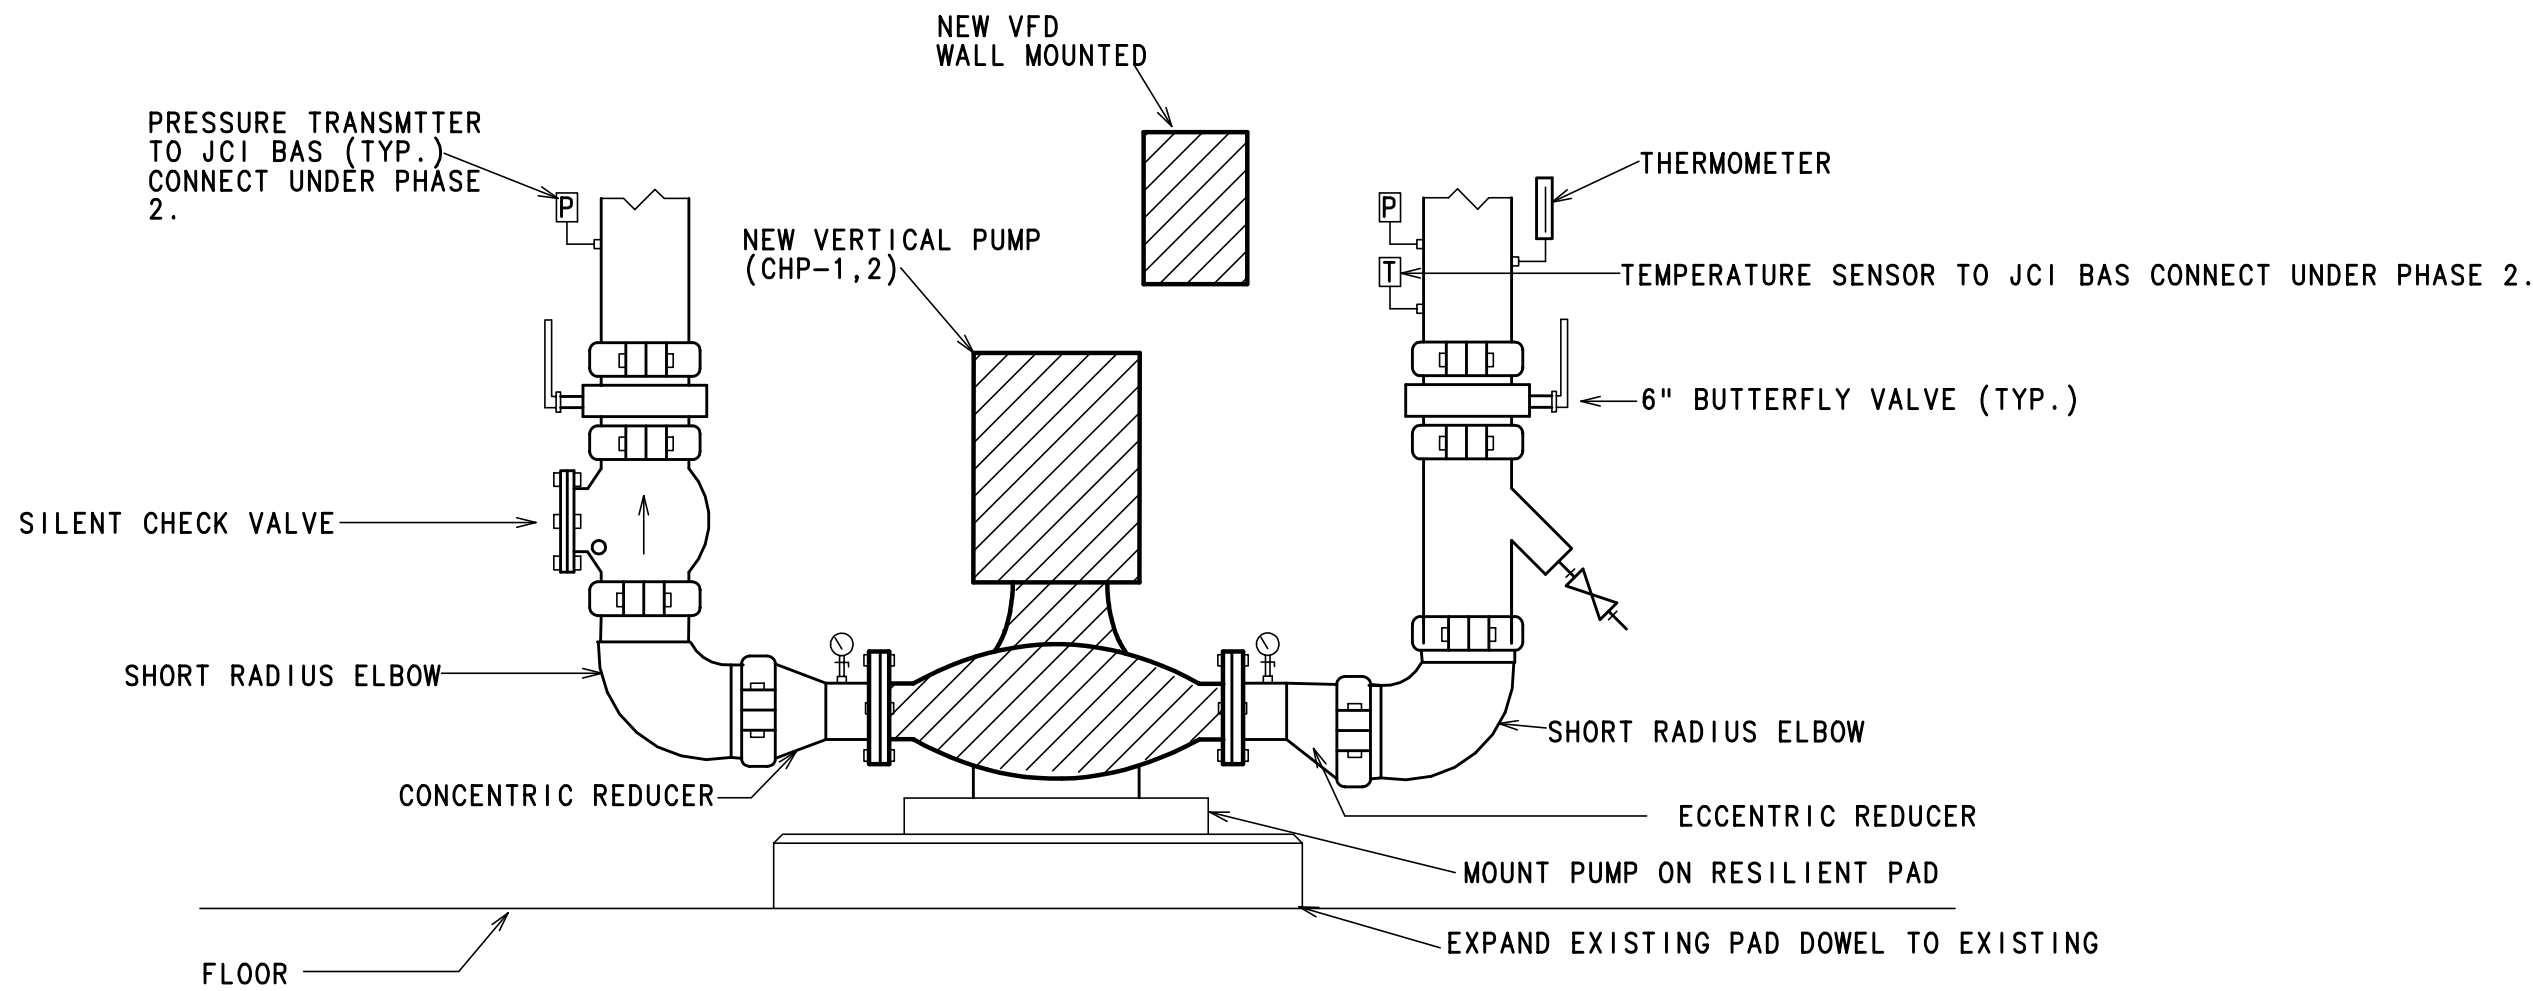


CHILLED WATER PUMP DETAIL

NO SCALE TYP. OF TWO

NOTE: INSTALL PUMP WITH SMALLEST PLAN FOOTPRINT POSSIBLE.
SPACE IS LIMITED TO INSTALL THE TWO PUMPS.
MAINTAIN WALKWAY TO SERVICE EQUIPMENT.

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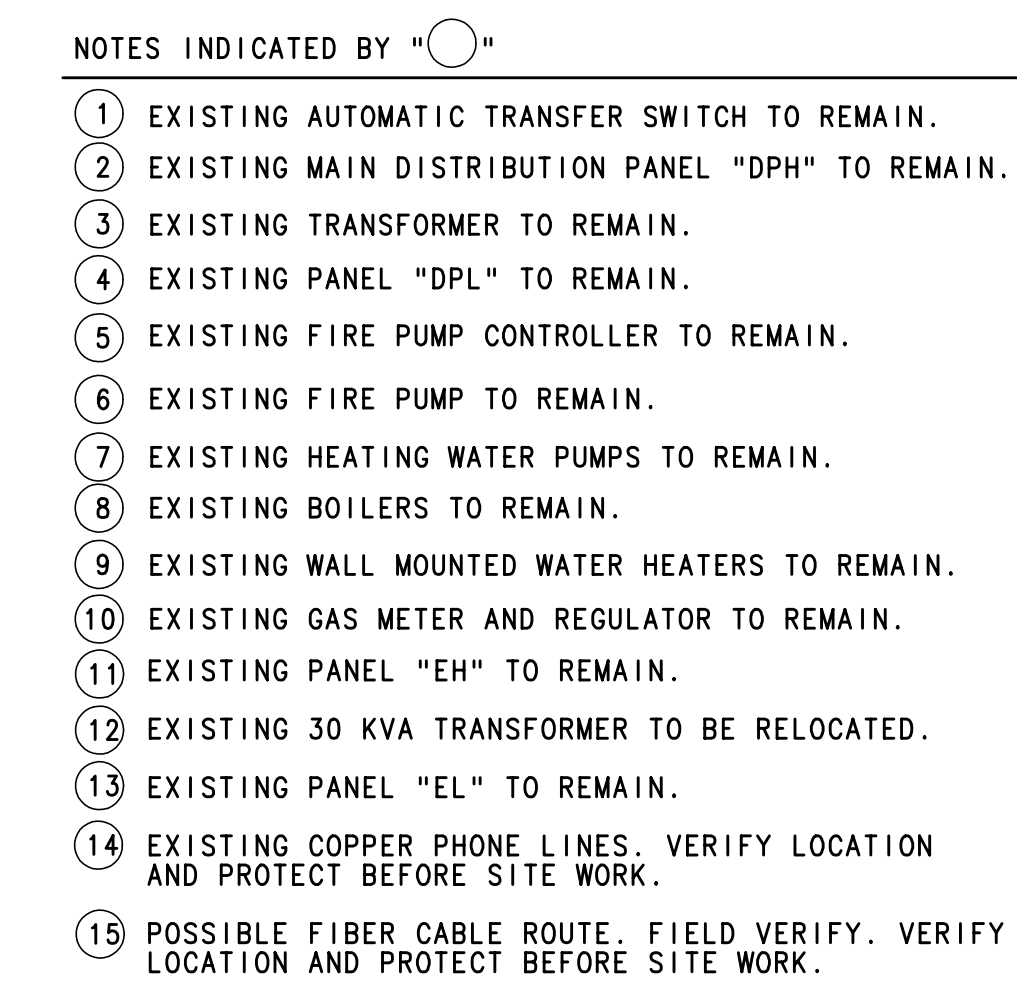
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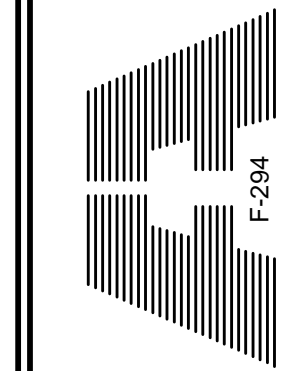
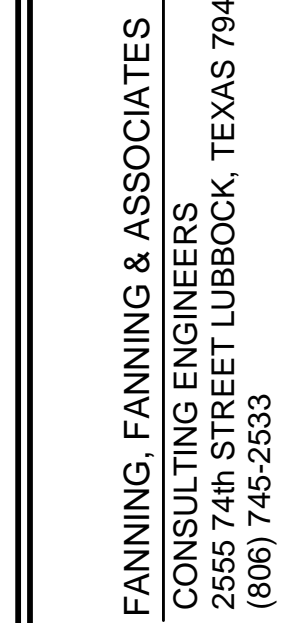
DRAWING NAME:
MECHANICAL
SCHEDULES
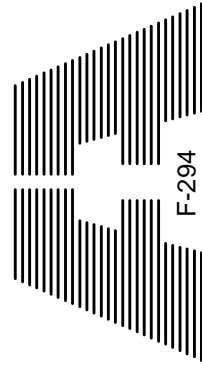
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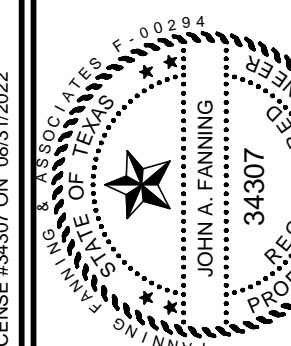
M106



GRAPHIC SCALE: $\frac{3}{16}'' = 1' - 0''$



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DEMOLITION
BASEMENT
FLOOR PLAN


JOB:	21038
DATE:	08/31/20
SHEET No.	

E000

PROVIDE NEW BREAKER FOR DHP-7 & 8

Existing Switchboard "DHP"									
CKT	SERVES	Ckt Brkr		CONDUCTORS / CONDUIT	Continuous VA		Non-continuous VA		
		Trip	Poles		Lights	Load2	Recept	Load4	Load5
M	1200	1200	3	See Riser Diagram					
1	Transformer	450	3	See Riser Diagram					
2	Panel CH	600	3	See Riser Diagram					
3	Space								
4	Pump 1	40	3	4 # 8, # 10G in 3/4" C.					
5	Panel EH-(ATS)	225	3	4 # 4/0, # 4G in 2.5" C.					
6	Pump 2	40	3	3 # 8, # 10G in 3/4" C.					
7*	New CHP-1	60	3	4 # 4, #10IG in 1.25" C.				22,437	22,437
8*	New CHP-2	60	3	4 # 4, #10IG in 1.25" C.				22,437	22,437
9	Space								
10	Space								
11	Space								
12	Space								
13	Space								
SERVICE: 277/480 volt, 3 phase, 4 wire + G								44,874	44,874
MAINS: 1200A Main Bus								44,874	44,874
Mounting: Free Standing									
SCCR (RMS Sym) = 32K									
Notes: (1) Existing Copper Bussing (2) New Custom Laminated Nameplates (3) New Typed Circuit Directory (4) *Provide New Breaker. (5) New Service Entrance Label (NEC 110.16(B)) (6) New Arc-Flash Warning Label (NEC 110.16)					PANEL CONNECTED VA		44,874		
					PANEL DEMAND VA		44,874		
					PANEL CALCULATED VA		44,874		
					PANEL SPARE VA		8,975		
					PANEL DESIGN VA		53,849		
					PANEL CONNECTED AMPS / PHASE		54		
					PANEL DEMAND AMPS / PHASE		54		
					PANEL DESIGN AMPS / PHASE		65		
					Nameplate Info Below (White Letters on Black)				
					Existing Switchboard "DHP"				
					277/480 Volt				
					Fed From Utility Transformer				

Existing Panel "CH"										
CKT	SERVES	Ckt Brkr		CONDUCTORS / CONDUIT	Continuous VA		Non-continuous VA		Total VA	
		Trip	Poles		Lights	Load2	Recept	Load4		Motors
1	Chiller	300	3	3 # 350, # 4G in 2.5" C.						
2	Future DOAS-1	110	3	3 # 2, # 6G in 1.25" C.			73,128		73,128	
3	Chiller	300	3	3 # 350, # 4G in 2.5" C.						
4	Future DOAS-2	110	3	3 # 2, # 6G in 1.25" C.			73,128		73,128	
5	Main 600A MCB	600		See Riser Diagram						
6	Space									
7	XXX									
8	Pump	70	3	3 # 4, # 8G in 1" C.						
9	XXX									
10	Pump	70	3	4 # 4, # 8G in 1.25" C.						
11	XXX									
12	XXX									
	XXX									
	XXX									
SERVICE: 480 volt, 3 phase, 3 wire + G								146,256	146,256	
MAINS: 600A MCB								146,256	146,256	
MOUNTING: Surface NEMA 3R										
SCCR (RMS Sym) = 30K										
Notes: (1) Existing Copper Bussing (2) Existing Hinged Door (3) New Custom Laminated Plastic Nameplate (4) New Typed Circuit Directory (5) New Arc-Flash Warning Label (NEC 110.16)					PANEL CONNECTED VA		146,256			
					PANEL DEMAND VA		146,256			
					PANEL CALCULATED VA		146,256			
					PANEL SPARE VA		36,564			
					PANEL DESIGN VA		182,820			
					PANEL CONNECTED AMPS / PHASE		176			
					PANEL DEMAND AMPS / PHASE		176			
					PANEL DESIGN AMPS / PHASE		220			
					Nameplate Info Below (White Letters on Black)					
					Existing Panel "CH"					
					277/480 Volt					
					Fed From Panel "DHP"					

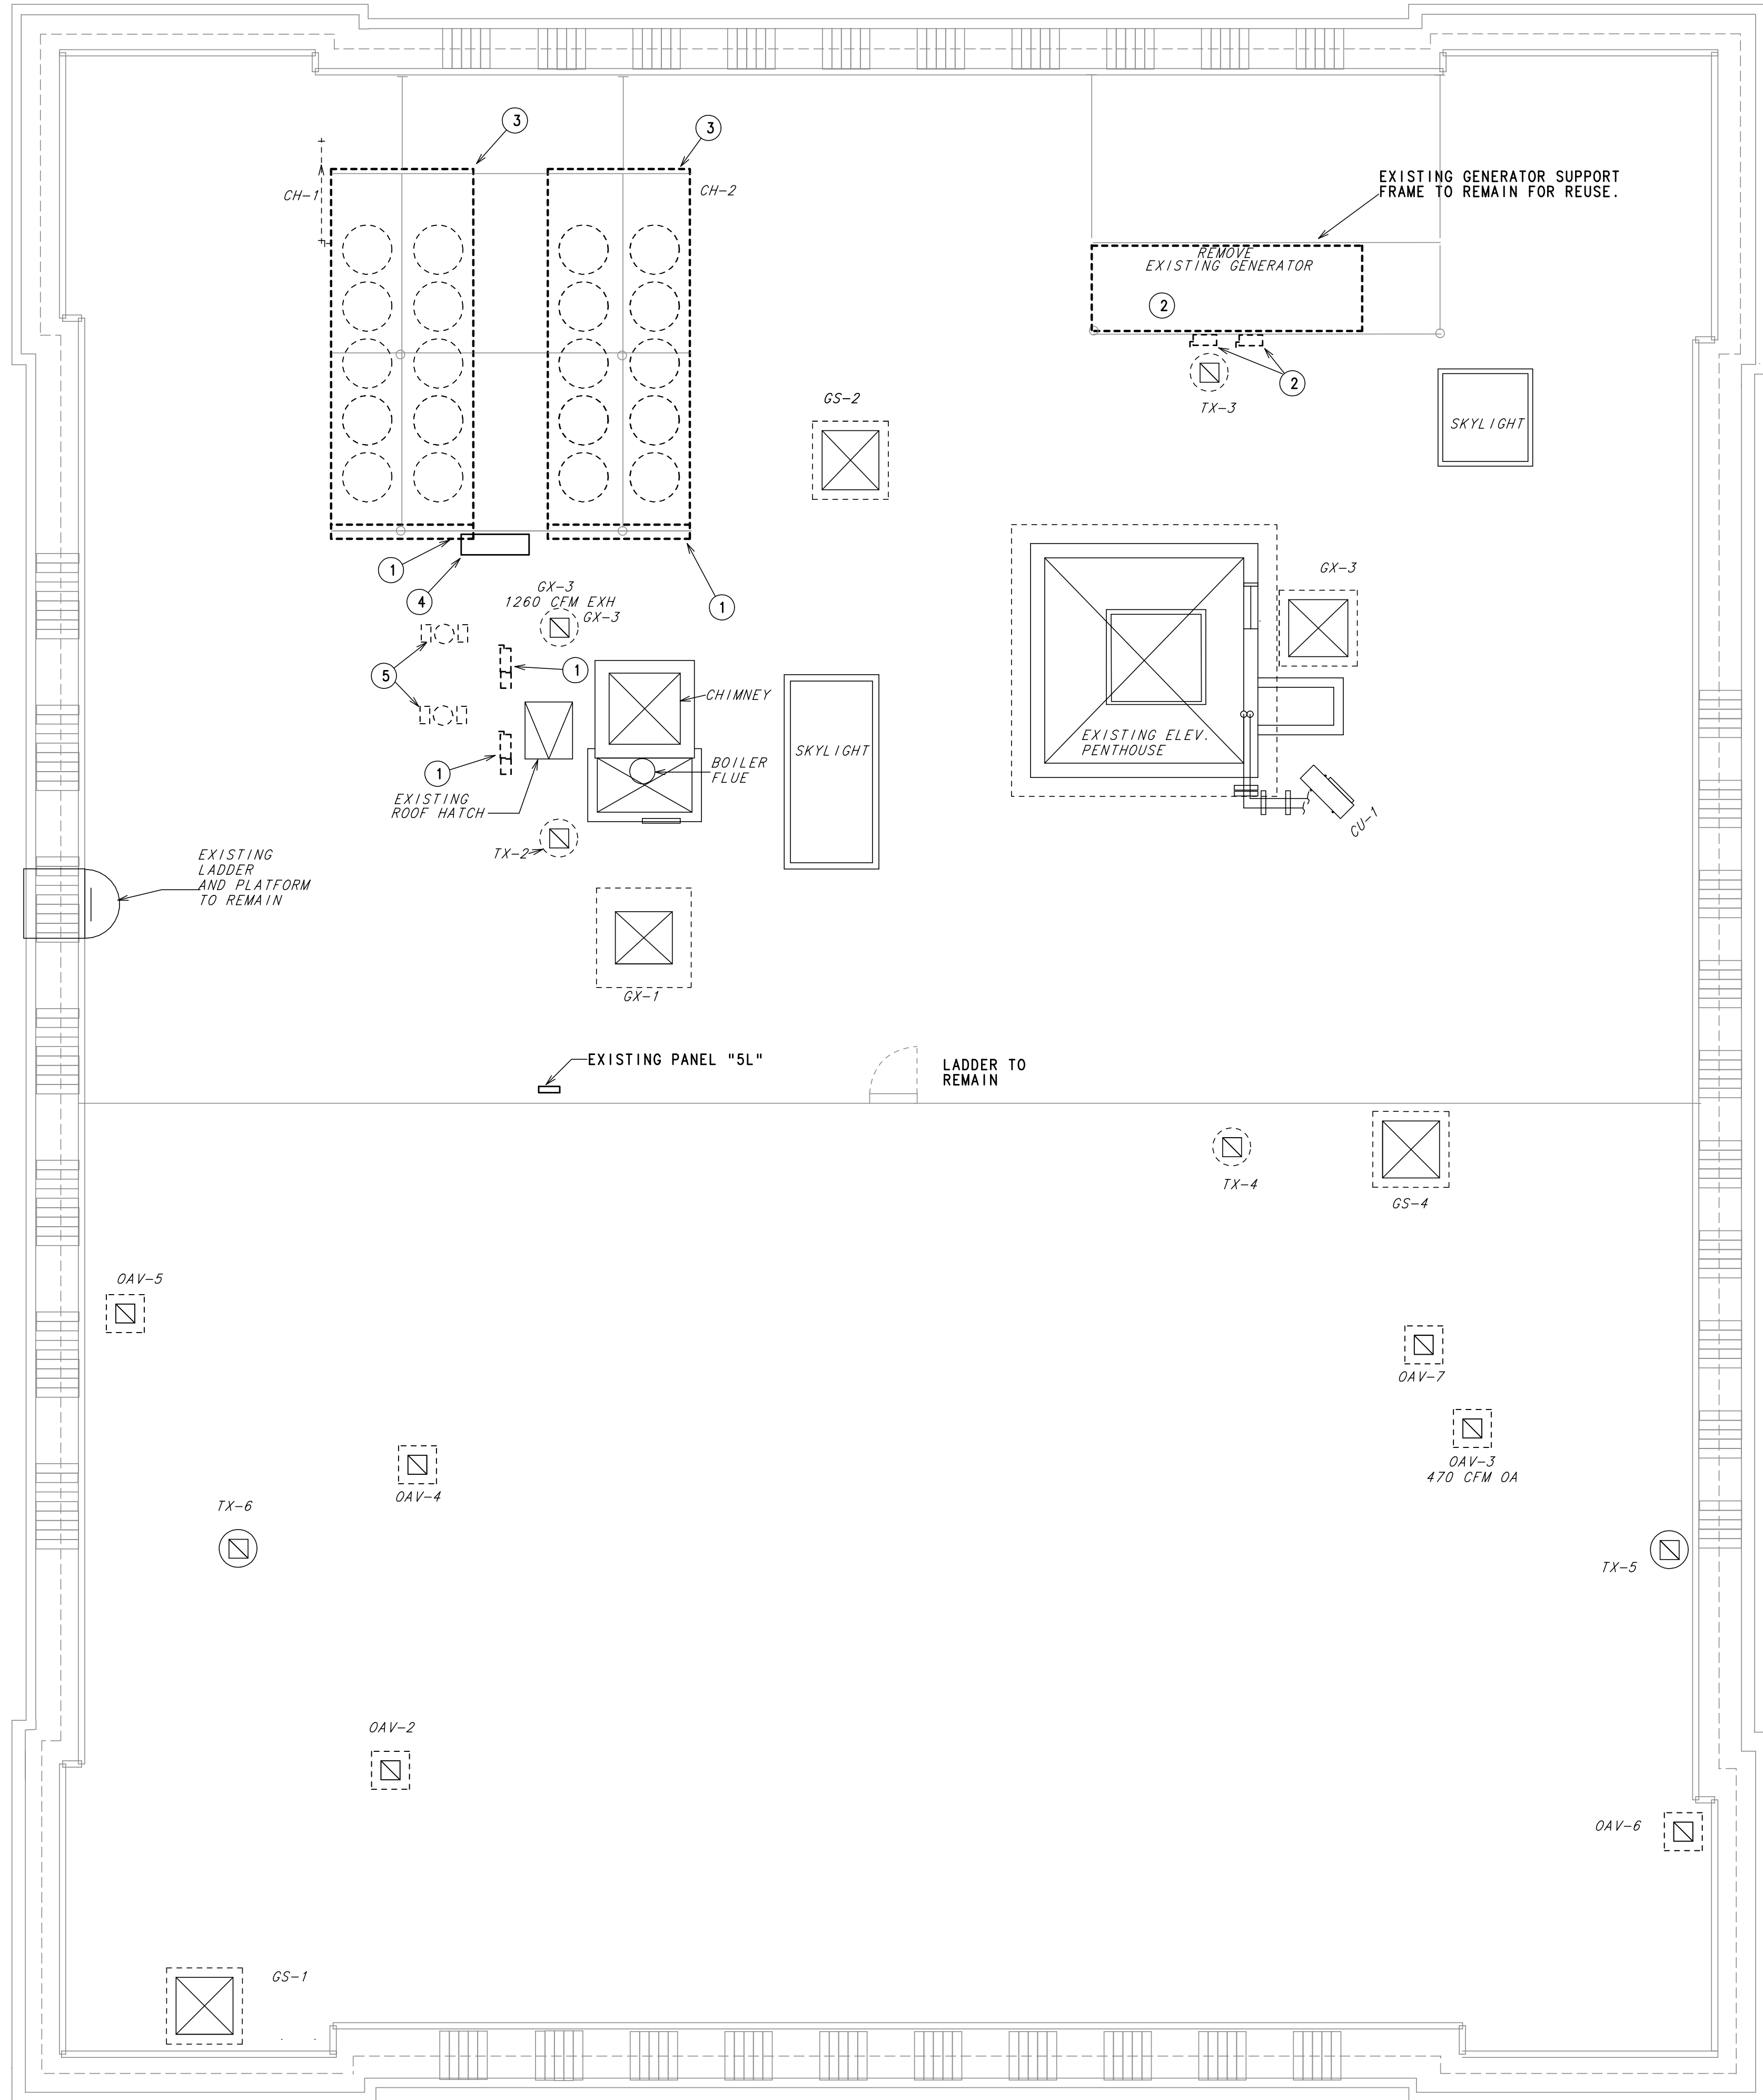

DEMOLITION ROOF PLAN - ELECTRICAL

GRAPHIC SCALE: 3/16" = 1'-0"




NOTES INDICATED BY "○":

- REMOVE CONDUIT AND CONDUCTORS BACK TO PANEL "CH".
- EXISTING GENERATOR TO BE RELOCATED. REMOVE CONDUIT AND CONDUCTOR TO AUTOMATIC TRANSFER SWITCH AND PANEL "EL".
- EXISTING CHILLER TO BE RELOCATED.
- EXISTING PANEL "CH" TO REMAIN. REMOVE CONDUIT AND CONDUCTORS FOR CHILLERS AND PUMPS BEING REMOVED.
- EXISTING PUMPS TO BE REMOVED.

New Panel "NG"									
CKT	SERVES	Ckt Brkr		CONDUCTORS / CONDUIT	Continuous VA		Non-continuous VA		Total VA
		Trip	Poles		Lights	Load2	Recept	Load4	
1	Lights	20	1	2 # 12, # 12G in 3/4" C.	54				54
2	Heater	20*	1	2 # 12, # 12G in 3/4" C.		1800			1800
3	Battery Charge	20	1	2 # 12, # 12G in 3/4" C.			840		840
4	Receptacle	20	1	2 # 12, # 12G in 3/4" C.		180			180
5	Spare	20	1	-----					
6	Spare	20	1	-----					
7	Spare	20	1	-----					
8	Spare	20	1	-----					
9	Spare	20	2	-----					
10	Space	20	1						
SERVICE: 120/208 volt, 1 phase, 3 wire + G MAINS: 60A MCB MOUNTING: Surface NEMA 3R SCCR (RMS Sym) = 10K					54	1800	180	840	2874
					54	1800	180	840	
Notes: (1) Copper Bussing (2) Hinged Door (3) Custom Laminated Plastic Nameplate (4) Typed Circuit Directory (5) 100% Neutral (6) Arc-Flash Warning Label (NEC 110.16) (7) *Verify Breaker & Conductor Size for Equipment Being Installed.					PANEL CONNECTED VA				2874
					PANEL DEMAND VA				2874
					PANEL CALCULATED VA				3388
					PANEL SPARE VA				575
					PANEL DESIGN VA				3912
					PANEL CONNECTED AMPS / PHASE				8
					PANEL DEMAND AMPS / PHASE				8
					PANEL DESIGN AMPS / PHASE				11
					Nameplate Info Below (White Letters on Black)				
					New Panel "NG"				
					120/208 Volt				
					Fed From Panel "YC"				

New Panel "YC"					MINI POWER ZONE				
CKT	SERVES	Ckt Brkr		CONDUCTORS / CONDUIT	Continuous VA		Non-continuous VA		Total VA
		Trip	Poles		Lights	Load2	Recept	Load4	
1	GFCI Receptacle	20	1	2 # 12, # 12G in 3/4" C.			180		180
2	Heat tape	20*	2	2 # 10, # 10G in 3/4" C.*		1500			1500
3	Panel "NG"	30	2	3 # 8 & # 10G in 1" C.	54	1800	180	840	2874
4	New Temperature Control Circuit	20*	1	2 # 12, # 12G in 3/4" C.*				500	500
5	Spare	20	1						
6	Spare	20	1						
7	Spare	20	1						
8	Spare	20	1						
SERVICE: 120/240 volt, 1 phase, 3 wire + G MAINS: 80A MCB MOUNTING: Surface NEMA 3R SCCR (RMS Sym) = 42K					54	3300	360	1340	5054
					54	3300	360	1340	5054
Notes: (1) Copper Bussing (2) Hinged Door (3) Custom Laminated Plastic Nameplate (4) Typed Circuit Directory (5) 100% Neutral (6) Arc-Flash Warning Label (NEC 110.16) (7) *Verify Breaker & Conductor Size for Equipment Being Installed					PANEL CONNECTED VA			5054	
					PANEL DEMAND VA			5054	
					PANEL CALCULATED VA			5893	
					PANEL SPARE VA			1011	
					PANEL DESIGN VA			6903	
					PANEL CONNECTED AMPS / PHASE			14	
					PANEL DEMAND AMPS / PHASE			14	
					PANEL DESIGN AMPS / PHASE			19	
					Nameplate Info Below (White Letters on Black)				
					New Panel "YC"/Transformer 120/208 Volt Fed From Utility Service				

FANNING, FANNING & ASSOCIATES
CONSULTING ENGINEERS
2555 74th STREET LUBBOCK, TEXAS 79423
(806) 745-2533

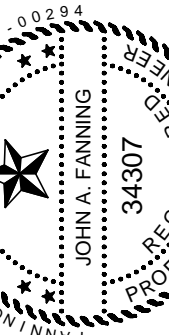

LAMAR COUNTY COURTHOUSE
HVAC SYSTEM RENOVATION PHASE 1

119 NORTH MAIN
PARIS, TEXAS 75460


REVISIONS	NO.	DATE	DESCRIPTION
	1	08/31/2022	ISSUE FOR BIDS

DRAWN BY:
DESIGN BY:

DRAWING NAME:
ELECTRICAL
DEMOLITION
ROOF PLAN

JOB: 21038B
DATE: 08/31/2022
SHEET NO:

E001

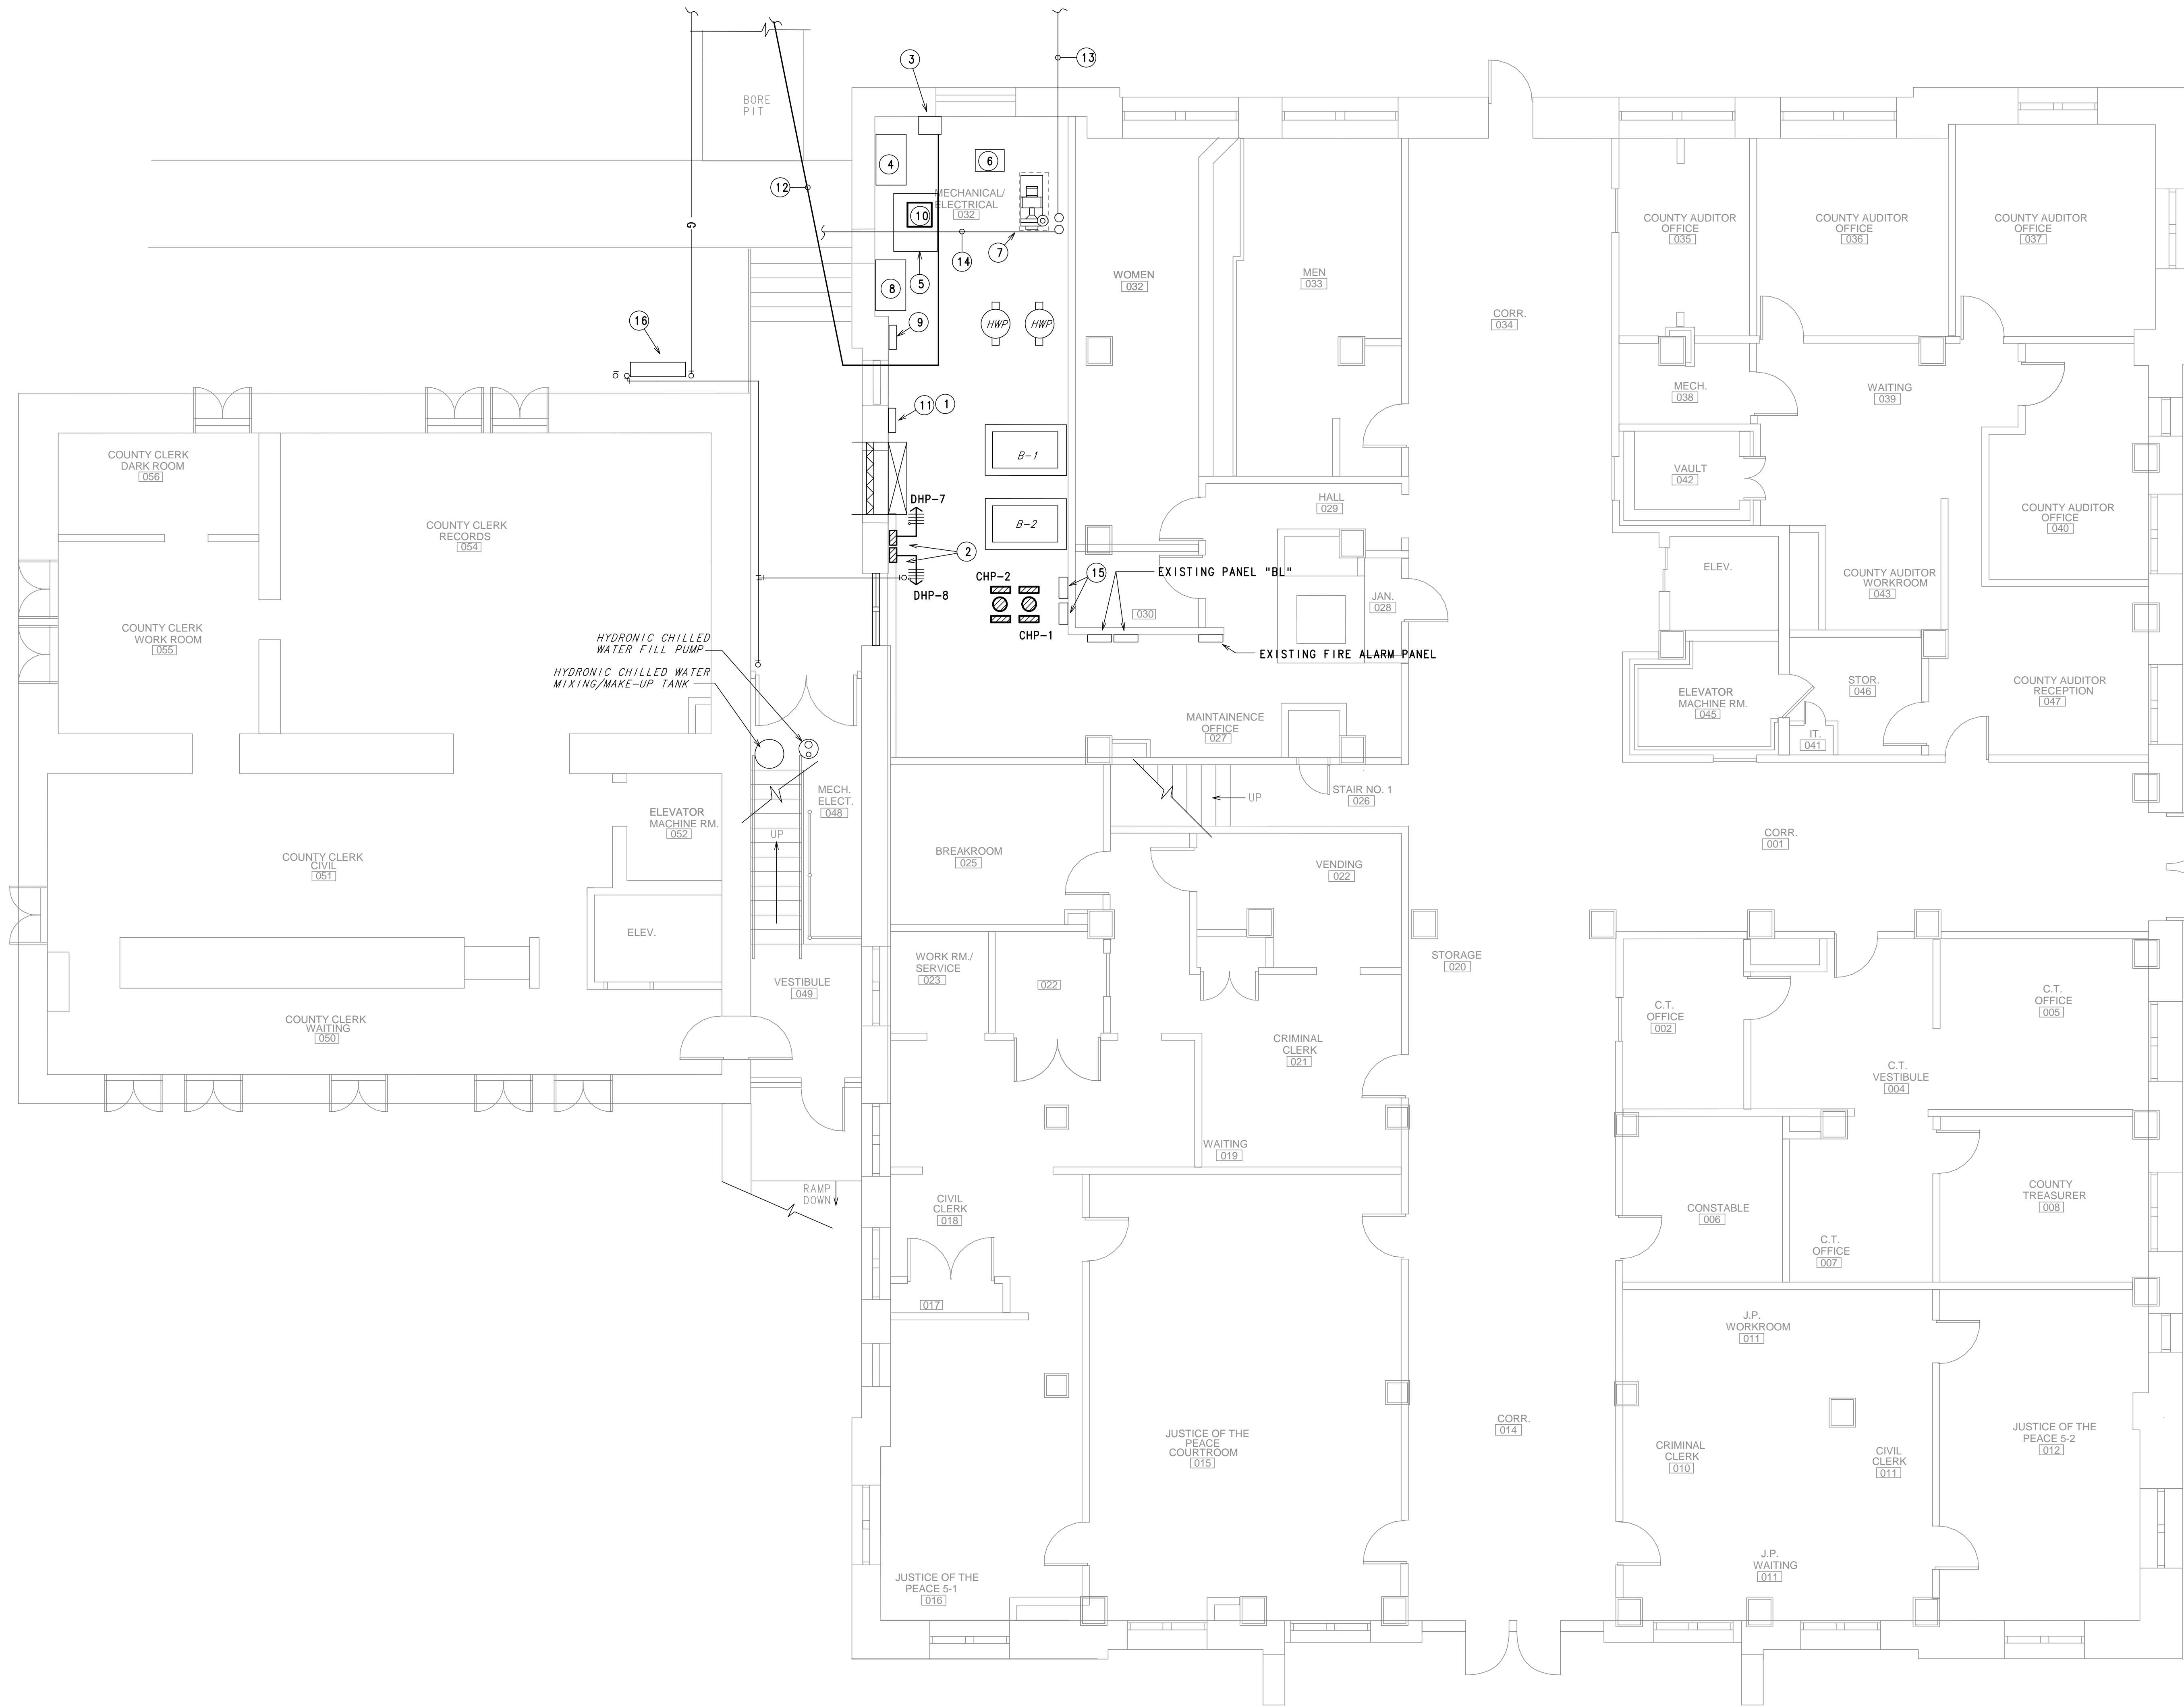

NEW BASEMENT FLOOR PLAN - ELECTRICAL

GRAPHIC SCALE: 3/16" = 1'-0"



NOTES INDICATED BY "○":

1. INSTALL NEW INNER SHIELD IN EXISTING PANEL.
2. NEW DISCONNECT/CONTROLLERS FOR NEW PUMPS CH-1 AND CH-2.
3. EXISTING ATS TO HAVE EXISTING CONDUCTORS AND CONDUITS TO ROOF MOUNTED GENERATOR REMOVED. INSTALL NEW CONDUITS AND CONDUCTORS TO NEW GENERATOR LOCATION.
4. EXISTING "DPH" TO HAVE NEW BREAKERS INSTALLED FOR NEW PUMPS CHP-1 AND CHP-2.
5. EXISTING 300KVA TRANSFORMER TO REMAIN.
6. EXISTING FIRE PUMP CONTROLLER TO REMAIN.
7. EXISTING FIRE PUMP TO REMAIN.
8. EXISTING PANEL "DPL" TO REMAIN.
9. EXISTING PANEL "EH" TO REMAIN.
10. EXISTING 30 KVA TRANSFORMER TO BE RELOCATED. CONSTRUCT A UNI-STRUT FRAME TO SUPPORT THE RELOCATED TRANSFORMER OVER THE EXISTING 300KVA TRANSFORMER. EXTEND CONDUIT AND CONDUCTORS AS REQUIRED. FIELD VERIFY WORK REQUIRED. SUPPORT FRAME SHALL BE INDEPENDANT FROM EXISTING 300KVA TRANSFORMER.
11. EXISTING PANEL "EI" TO REMAIN. REMOVE CONDUCTORS THAT FEED GENERATOR COOLANT HEATER, AND BATTERY CHARGER ON ROOF.
12. EXTEND 4 #250 & #4 GND IN 4" CANTEX CAN-GRIP OR EQUAL CONDUIT FROM EXISTING AUTOMATIC TRANSFER SWITCH TO RELOCATED GENERATOR. PROVIDE ONE ADDITIONAL EMPTY 4" CONDUIT. INSTALL AN ADDITIONAL 1" CONDUIT FOR CONTROL AND ANNUNCIATOR WIRING.
13. EXISTING ATT COPPER PHONE LINES. VERIFY LOCATION AND PROTECT BEFORE SITE WORK.
14. POSSIBLE SUDENLINK FIBER OPTIC CABLE RUN. FIELD VERIFY LOCATION AND PROTECT BEFORE SITE WORK.
15. EXISTING WALL MOUNTED WATER HEATERS TO REMAIN.
16. EXISTING GAS METER AND PIPING TO REMAIN.

ELECTRICAL LEGEND

SYMBOL	DESIGNATION
	GROUND FAULT INTERRUPTER RECEPTACLE
	JUNCTION BOX
	LIGHTING AND APPLIANCE PANEL
	DISTRIBUTION PANEL
	CIRCUIT INDICATION(NO. OF WIRES:GROUND/HOT/NEUTRAL SHOWN)
	SWITCH LEG INDICATION
	CIRCUIT RUN TO PANEL(NO. OF WIRES SHOWN)
	MOTOR
	MOTOR CONTROLLER
	DISCONNECT SWITCH
	THERMOSTAT
GFCI	GROUND FAULT CIRCUIT INTERRUPTER
UG	UNDERGROUND

SERVICE DISCONNECT
MD-1
1 OF 3


SERVES: CH-1

WHITE PHENOLIC NAMEPLATE
(1/16" THICKNESS) W/BLACK LETTERS
WITH BEVELED EDGES

SERVICE DISCONNECT IDENTIFICATION DETAIL

ADDITIONAL NAMEPLATES:

MD-1 SERVES: CH-1
MD-2 SERVES: CH-2
MD-3 SERVES: TRANSFORMER PANEL "YC"

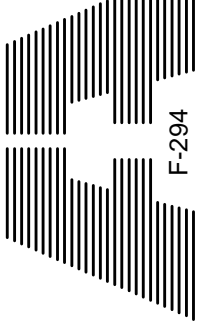

REVISIONS

NO.	DATE	DESCRIPTION
1	08/31/2022	ISSUE FOR BIDS

DRAW BY:

DESIGN BY:

DRAWING NAME:

ELECTRICAL
NEW
BASEMENT
FLOOR PLAN

JOB: 21038B

DATE: 08/31/2022

SHEET No.